

### Construction Operational Management Plan

Project Name:	Barangaroo Cutaway Cultural Facility	
Project Number:	200290	
Project Location:	1 Merriman St, Barangaroo NSW 2000	
Client:	Infrastructure NSW (INSW)	
Name of principal contractor:	FDC Construction (NSW) Pty Ltd	

22-24 Junction Street, Forest Lodge

**ABN:** 72 608 609 427

Peter
Prepared Signature Colak

Company address:

**Project Details** 

Digitally signed by Peter Colak Date: 2024.04.26 08:23:53 +10'00'

Approved Signature Thomy

Digitally signed by Emma Thomy Date: 2024.04.26 08:56:37 +10'00'

Peter Colak

Emma Thomy

Senior Project Manager

Project Director



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#### Introduction

The Construction Operational Management Plan (COMP) shall be implemented in consultation with the Project team, Building Operations, and subcontractors. The purpose of this plan is to set out the construction sequence and operational controls to mange the site materials handling, movement of site and public and egress management.

This plan addresses project site specific emergencies identified in the management plans in table 1 and provides support to task specific emergency situations identified within the Site Risk Assessment.

#### SITE PLAN





#### 1.0 **PROJECT SCOPE**

The scope includes, but is not limited to the design and construction, and testing and commissioning of:

- Primary Use Areas inclusive of the Main Entry, Entry Foyer, Event Hall, Gallery & Exhibition Space, Education Space, Waranara Terrace, and associated amenities.
- Back of House Areas inclusive of a Security Control Centre, Loading Dock, Offices, Green Rooms, Event Kitchen, Storage Spaces.
- Service and Amenity areas inclusive of a Café and Retail/merchandising space.
- Management Offices including Precinct Management Office, Cutaway Management Office, and Facilities Management Office.
- New services including upgrades, connection to and augmentation of existing services.
- New skylight structure on the existing sandstone wall (the skylight support will impact on the top of the rock shelf and the adjacent existing concrete upstand, which will require additional structural strengthening to support the new enclosure).

#### 1.1 Site contacts

The site contacts will be available through the below team -





Chris Tapia Site Manager (Structure)



Foreman



Jorge Oancea **WHS Senior** Supervisor



Luke Trochei Site Manager (Fitout/Services)




Foreman (Fitout/Services)



FDC Made personal™




#### 1.2 After hours contacts –

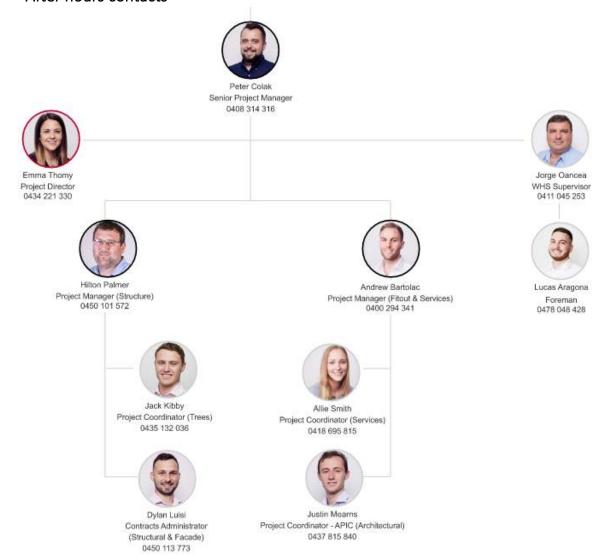

# 1.3 Construction Work Hours Monday to Friday 7am to 6pm Saturday 8am to 5pm No works Sundays



#### 1.4 Community Communication

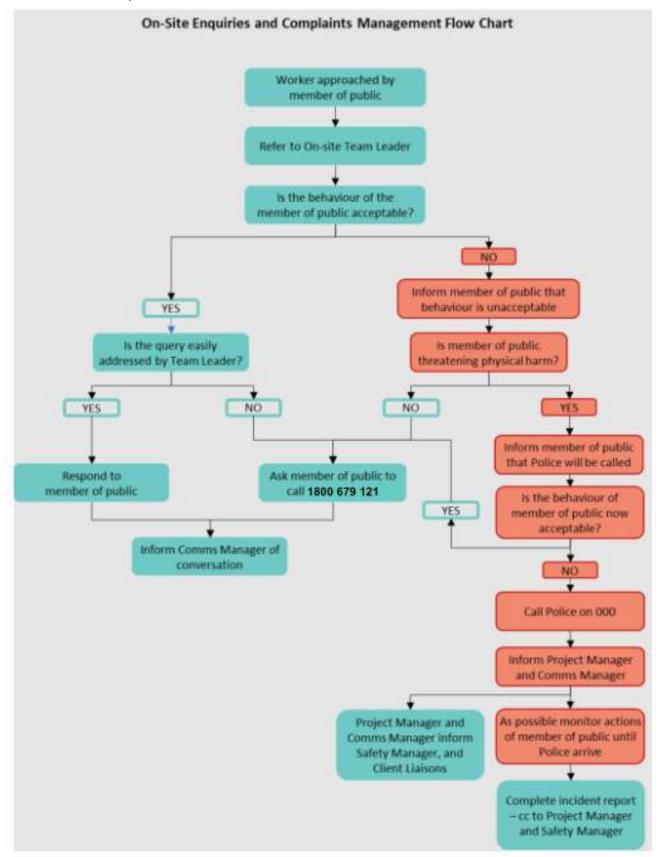




#### 1.5 Emergency Management Plan

The Cut away Emergency management plan has been developed around the constraints of the project and operational controls. as the project goes through its Lifecyle the EMP will be updated inline with the COMP.

The EMP can be found on Aconex, on the site notice board.

#### 1.6 Construction Sequence

The construction sequence will start form the Southern end of the project and running to the from the North with steel installation from level 2 to level 1, fit out works will take place in the same sequence, GRC and Timber tree install will sequence in their respective areas and move to the Northern end of the project.

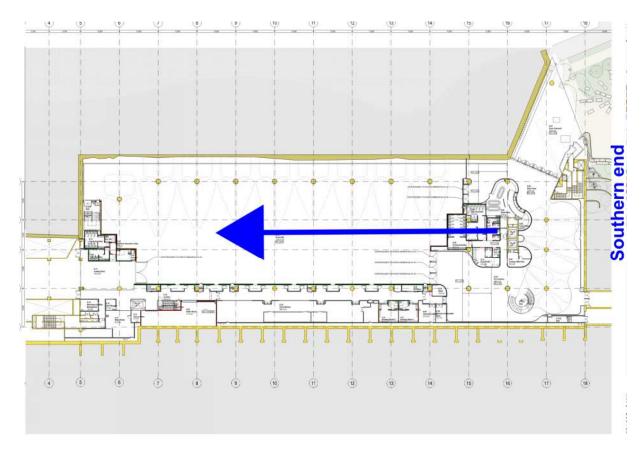



#### 1.7 Construction Management plans

The following Management plans were used to develop the Construction Operational Management Plan (COMP) if any changes are required to the COMP, then the below Management plans should be referred to.

Management Plan	DRAFT Rev	CONSTRUCTION Rev
Construction Environmental Management Plan	Rev 1	Rev C1
Quality Management Plan	Rev 1	Rev C1
Hazardous Materials Management Plan	Rev 2	Rev C1
WHS Management Plan	Rev 4	Rev C1
Aboriginal Management Plan	Rev 2	Rev C1
Training Management Plan	Rev 1	Rev C1
Workplace Relations Management Plan	Rev 1	Rev C1
Construction Traffic Management Plan	Rev 1	Rev C1
Soil and Water Management Plan	Rev 1	Rev C1
Design Management Plan	Rev 2	Rev C1
Emergency Management Plan	Rev 1	Rev C1
Communication Stakeholder Management Plan	Rev 2	Rev C1
Construction Waste Management Plan	Rev 1	Rev C1

Table 1.

#### 1.8 FDC Construction Minimum Requirements

The Cutaway project brief is detailed to set minimum requirements for the project in way of site establishment and management this is in Appendix A and is to be used by the project team and subcontractors to design and implement the site management protocols.

#### 1.9 Construction layout drawings

The construction layout drawings are in Appendix B, these plans identify the location of fire safety equipment, emergency egress locations, first aid locations, site amenities, access to site Plant and worker Separation and materials handling, these layout plans are checked each month and updated as required.

#### 1.10 Hoarding layout drawings

The hoarding layout drawing attached in appendix C identify the hoarding locations and type of hoardings these plans are to be used by the project team to establish public interface locations and weekly hoarding inspections will be completed to ensure the hoarding are compliant, any changes to the hoardings will be documented and updated in the plan.



#### 1.11 Emergency Egress drawings

The emergency egress drawing is to be updated each week with any construction activity changes, during the weekly review consideration of the egress paths and lighting designs are to be considered.

#### 1.12 Construction Fire safety Management Plan


The Construction Fire Safety Management Plan (CFSMP) is to inform the Project teams, Operational Management Group and Subcontractors of the Changed fire and safety management to the project this will include Project Construction areas and Public live areas. The plan is to be updated as the project goes through its life cycle.

#### 1.13 Cutaway Workforce Coordination Meeting (CWCM)

A daily coordination meeting will take place called Cutaway Workforce Coordination Meeting (CWCM) to align tasks and communicate exclusion zones, change of access, high risk works, issues resulting from site works and daily safety briefing to be undertaken the within the next 48hours the Subcontractors principle Site manager or Forman, will attend this meeting and be involved in the implementation of the daily worker notification prestart, the daily CWCM meeting will be recorded and issued out within the daily prestart communication through Project Simple, each worker will be required to attend their designated prestart with their company Forman / Site manager to ensure that the items discussed in the CWCM are explained and any issues raised reported back to FDC site management.



2.0 Appendix A - Cutaway Project Brief

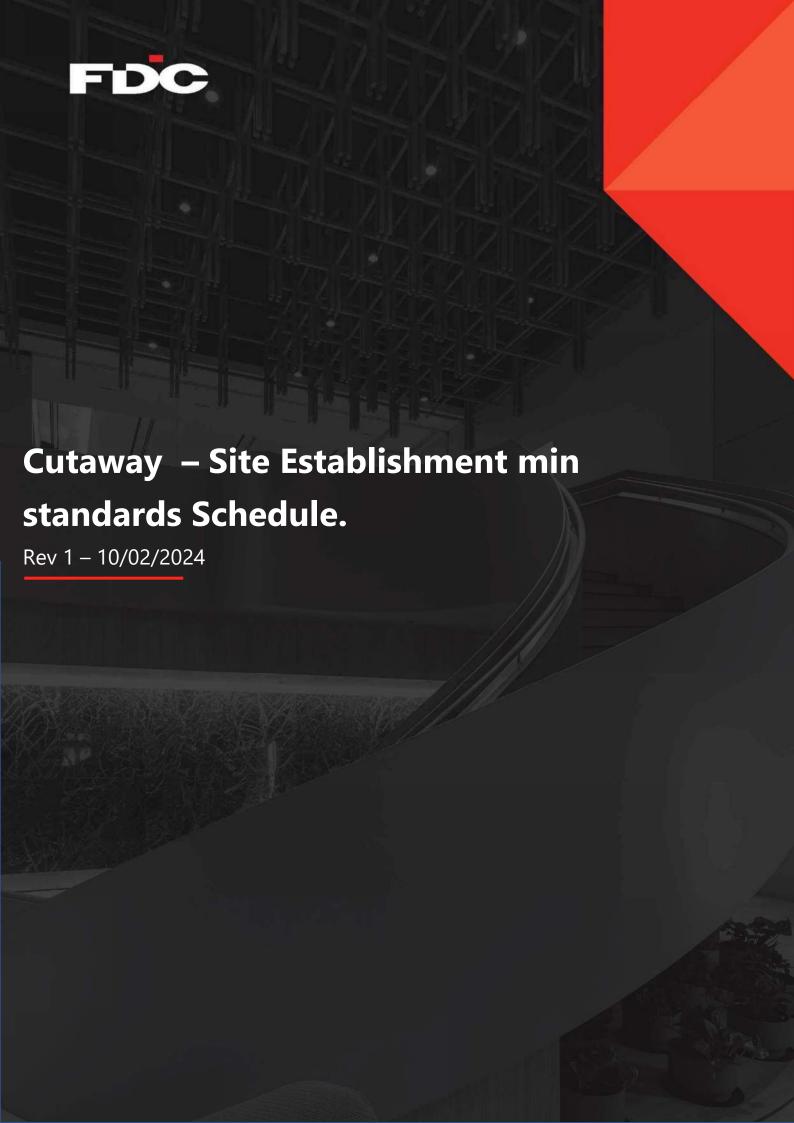



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#### **Temp Electrical**

#### Temp power boards and Power

All Temp electrical installation on FDC construction site must be reviewed and designed to AS/NZS 3012 and AS3000 the electrical contractor is to produce a temp lighting and power board management plan including design, installation, tagging and Electrical certifications and any required maintenance for the evolution of the project, the contractor will be required to relocate the lights and boards as required to allow continuity of construction works.

The electrical contractor is to allow for power supply (outside site amenities ) to 10 Temp toilets, 15 Bubblers, 2 Wash stations, construction hoist, and temporary Comms room

Commissioning and ongoing required testing is to be completed, recorded, and issued to FDC as required throughout the project.

Temp power boards Type A boards are to consist of the below requirements and be constructed in accordance of AS/NZS 3012

- Temp switch board are to be made of robust construction and materials to withstand mechanical damage from environment or other external influences that may be expected at the location.
- The enclosure shall have a degree of protection appropriate for the environment in which it is installed subject to a minimum degree of protection of IP23.
- Live parts shall always be effectively protected against contact by persons operating equipment located on the switchboard, including the connection or disconnection of plugs to socket-outlets.
- Switchboards shall be securely attached to a wall, floor, or other structure
- Type A boards should consist of at least 4 x DGPO 10amp supply
- Type B boards should consist of at least 4 x DGPO 10amp supply and 1 x 63amp Outlet c curve breaker.
- Prior to Connection all boards are to be inspected and signed off in collaboration with FDC and relevant forms signed off accordingly.






#### Temp lighting

All Temp electrical installation on FDC construction site must be reviewed and designed to AS/NZS 3012 and AS3000, AS2293. The electrical contractor is to produce a temp lighting and power board management plan including design, installation, tagging and Electrical certifications and any required maintenance for the evolution of the project, the contractor will be required to relocate the lights and boards as required to allow continuity of construction works.

Temp lighting to all parts of floors including all rooms, access stairs and s, Emergency egress paths, internal jump from decks, jump stairs, and all compliant exit running men signs and lighting on egress paths.

- Temp light is to be led type fitting with soft wiring connections, lights needs to be battery backup for 2 hours.
- Lighting system needs have compactly to integrate directional running man exit signs
- Lighting system needs to have electrical test switch to comply to AS2293
- Lighting system must have time clock of Sensors inline to allow for reduced energy usage
- Lighting system must have min lux requirements to satisfy AS/NZS 3012



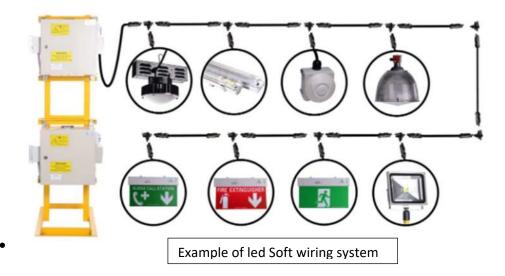

#### Temp lighting to formwork lead deck

Temp lighting – flood lights to leading construction deck prior to construction lighting installation the electrical contractor is to allow for early installation of flood lights to formwork decks to allow construction works to take place noting these will be removed or relocated once formwork deck is trafficable for height access equipment



Example of led crane type flood lights

#### Temp cabling

All Temp electrical Cabling on FDC construction site must be reviewed and designed to AS/NZS 3012, AS3000, AS2293.

- All Temp construction wiring other than low voltage must be mechanically protected with UV Stable conduits,
- All temp wiring should be installed against soffits where this is not achievable then the cabling should be installed no lower than 3m unless a risk assessment is completed and agreed with FDC.
- All construction wiring should be labelled at no further than 3m with construction wiring tape and at 5-meter intervals the below sign is to be installed in A4 and maintained by the electrical contractor throughout construction works.







#### Temp main switchboard

Any Temp Main switch board being installed to FDC construction site must be reviewed and designed to AS/NZS 3012, AS3000, AS/NZS 3439. 1 and 3439.3

- Temp Main distribution board will be able to take feeds direct From either Ausgrid substation or MSBR
- Board will need to be designed to allow free standing positioning
- Board will need to be lockable and external powder coated.
- Board will need to IP rated to 64 or suitable for external all weather conditions.



#### Example of main switch board free standing

#### Max power demands for equipment

Item	Description	Max	Location	Owner
		Power		
003	Construction hoist	122A	Level 1	TBC
005	Construction Power	TBC BY Project	All levels	Site Electrician
		Electrician		

\*\*\* Spec sheets on equipment TBC \*\*\*\*



#### **Hydraulics**

#### **Bubblers**

The hydraulic contractor is to supply a water supply and bubbler management bubblers are to be located in each floor and external work area with nominal minimal distance of 100m apart Bubbler to have chilled water.

- Bubbler to be fitted with bubbler and bottle filling spout
- Bubbler to max 10amp plug with plug cover guard to stop unplugging of device
- Bubblers are to be drained to sewer stack points



Example of Bubbler with bottle filling spout

#### Hose Taps

Hose taps are to be installed throughout the site with coverage of no less the 30m form any hose tap the Hydraulic contractor is to prepare a management plan that outlines the hose tap locations, management throughout the build and relocations as required. Noting the below requirements

- Hose taps are to be connect to main feed line.
- Each floor is to have an independent isolation valve.

#### Wash out stations

2 Washout stations are to be implemented on the project Hydraulic contractor to supply a detailed plan with Washout locations prior to installation for sign off by the site team an additional allowance to relocate as required throughout the project evaluation.

- Wash stations are to be fitted with filtration systems and water reuse abilities
- Wash stations will need to have documented water saving data showing reduction in water use.
- Wash stations will need to be maintained and cleaned within specifications.





https://washbox.global/trolley-mounted-model/

#### Temp toilets to floors

Compliant temp toilets are to be installed to every floor connected to a main sewer stack and towns water these toilets are to install and maintained throughout the project toilets are to be relocated to suit changing scope and to be installed within 48hours of new floors being established





#### Wet fire

#### Temp Fire hydrants during construction and Booster

During construction the Fire hydrant system will be managed through temp hydrant line located to compliant locations to the project the fire contractor is to outline a fire hydrant management plan for sign off by FDC site and service teams, noting compliance to relative standards of no more than 2 floors below the leading deck.

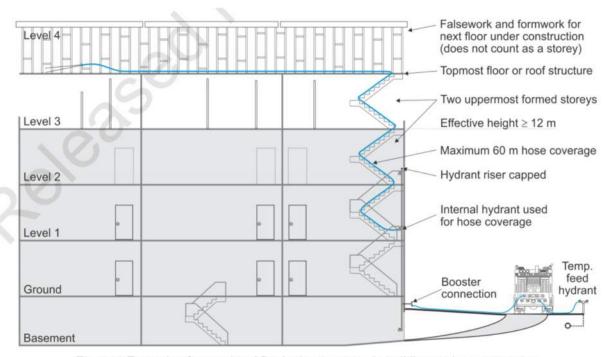


Figure 1 Example of operational fire hydrant system in building under construction

#### Fire extinguishers

During construction the fire contractor is to supply a management plan for the duration of the build outlining the design, install and service the Temporary fire extinguishers layout to each floor this includes the relocation, tagging and repairs as required to allow construction works to proceed.

- Extinguishers will be located on each floor no more than 2m from any entry and exit points.
- Fire extinguisher will be installed and signage as to current Australian Standards
- Fire extinguishers will be 4.5kg AB(E)
- Fire extinguishes will be deployed to all false work areas







#### Implementation and management of block and elevation plans

During construction All fire safety documentation will be maintain by the relevant contractors and kept next to the booster assembly within the emergency information box.

These documents consist of the following

- General layout of the current building noting live areas
- Most recent copy of the construction plans
- Current evacuation plans and egress paths
- Fire safety report
- Location of hazards storage
- Block plan
- Hydrant locations plan
- Isolation vales plan



#### Fire - Dry

Early detection smoke and thermal detectors

Early detection thermals are to be installed into -

- Temp comms room in basement for security cupboard
- Existing DAS rooms
- Overall Slab soffit and lunchrooms/ facilities
- Fire stairs
- Basement/ loading dock entry



#### Nurse call

#### Nurse call base station

- Nurse call base station needs to be compatible with phone notification and voice over radio
- Base station must have compacity to receive 23 call points

#### Nurse call device types

- Call points need to be first aid and evac type and located as to Site establishment plans.
- Manual Fire call points to be implemented as to Site establishment plan



#### Safe operating zone barriers

#### General and EWP safe operating zone Barriers

- Barriers to be implemented when hazards outlined in Risk assessments are present
- Barriers are to be continues flags with ropes on T bollards and spread no more than 3m apart
- Signage is to be installed clearly outline the type of works date duration and person responsible details name, Phone number, Company.
- Designated entry point with suitable retractable gate is to be installed as part safe operating zone plan





#### Safe operating zone barriers – overhead works

- Safe operating barriers to be implemented when hazards outlined in Risk assessments are present while over head work are taking place
- Barriers are to be continues interlocking fencing min 1.1m high
- Signage is to be installed clearly outline the type of works date duration and person responsible details,
  - o Name
  - o Phone number
  - o Company
- Designated entry point with suitable locking gate is to be installed as part safe operating zone plan.



#### Edge protection

#### Perimeter Handrails

Perimeter handrail are to be installed where a risk of falling is greater than 800mm.

- Perimeter handrails are to be 1000mm or greater
- Where perimeter handrails are installed 20X20 fibre mech is to be installed up to underside of slab and affixed to the perimeter handrail.
- Not holes greater than 20mm is to be in handrail



Debre mesh is to be used where fencing is closer than 40mm form slab edge





#### Perimeter and internal scaffold

Perimeter scaffold is to be installed to all floors where screens are not installed.

- Scaffold to have a working weight 675kg per working deck
- Scaffold to have fire retardant chain and mesh to all external faces
- Scaffold to have 1m clear access in bays and double hob ups
- Scaffold decks to be 2m intervals
- Scaffold to have access stair to Erskine street and Stretcher stair to Clarence street
- Scaffold to be compliant to relevant Aust standards
- For mor information please refer to FDC edge protection guidance notes

#### Site access control system

Site access point will be from Clarence street through site turnstile

All workers and visitors will pass through turnstiles to access site.






All trades to provide compliance to relevant codes and standards for temps. FDC has provided indicative layouts only as noted on the plan.

Site Establishment key plan				
Item	Description	Item reference symbol		
001	Type A switch board 10amp DGPO	Туре А		
002	Type B switch board 10amp DGPO and 64amp 3 phase power socket	Туре В		
003	Main switch board feed form Substation	Main switch board		
004	Low voltage lighting	Lighting		
005	Compliant exit running man feed from Lighting low voltage system	Exit signs		
006	Crane led flood light for leading deck	Crane light		
007	Hose tap location	Hose tap		
800	Bubbler location	Bubbler		
009	Temp toilet location	Temp toilet		
010	Fire extinguisher Location	Fire Extinguisher		
011	Fire hose reel and Fire hydrant landing Valve	FHR / FH		
012	Fire hydrant booster location	Fire hydrant booster		
013	Emergency information Box	Emergency information Box		
014	Nurse call point	Nurse call point		
015	Egress path			
016	Access stair			
017	Stretcher stair			




018	Man, and material hoist location	
019	Materials Hoist location	
020	Turn stile	
021	Wash station	Wash station

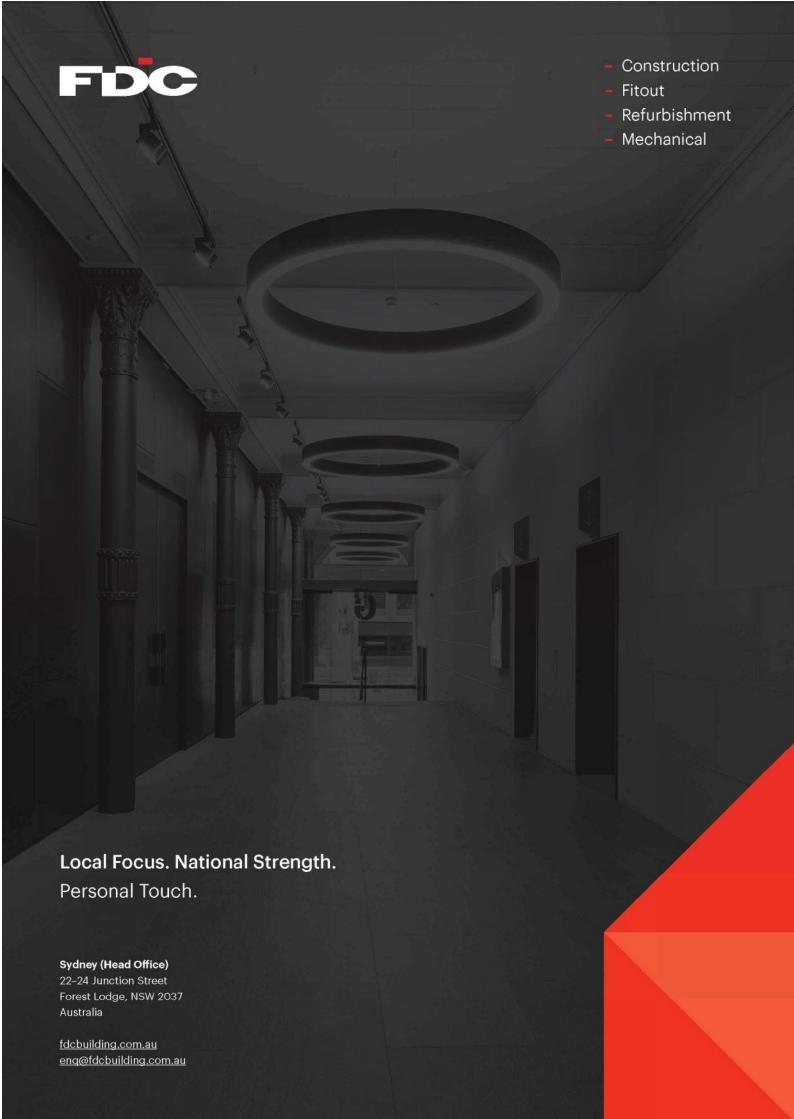




### 3.0 Appendix B – Construction Plans

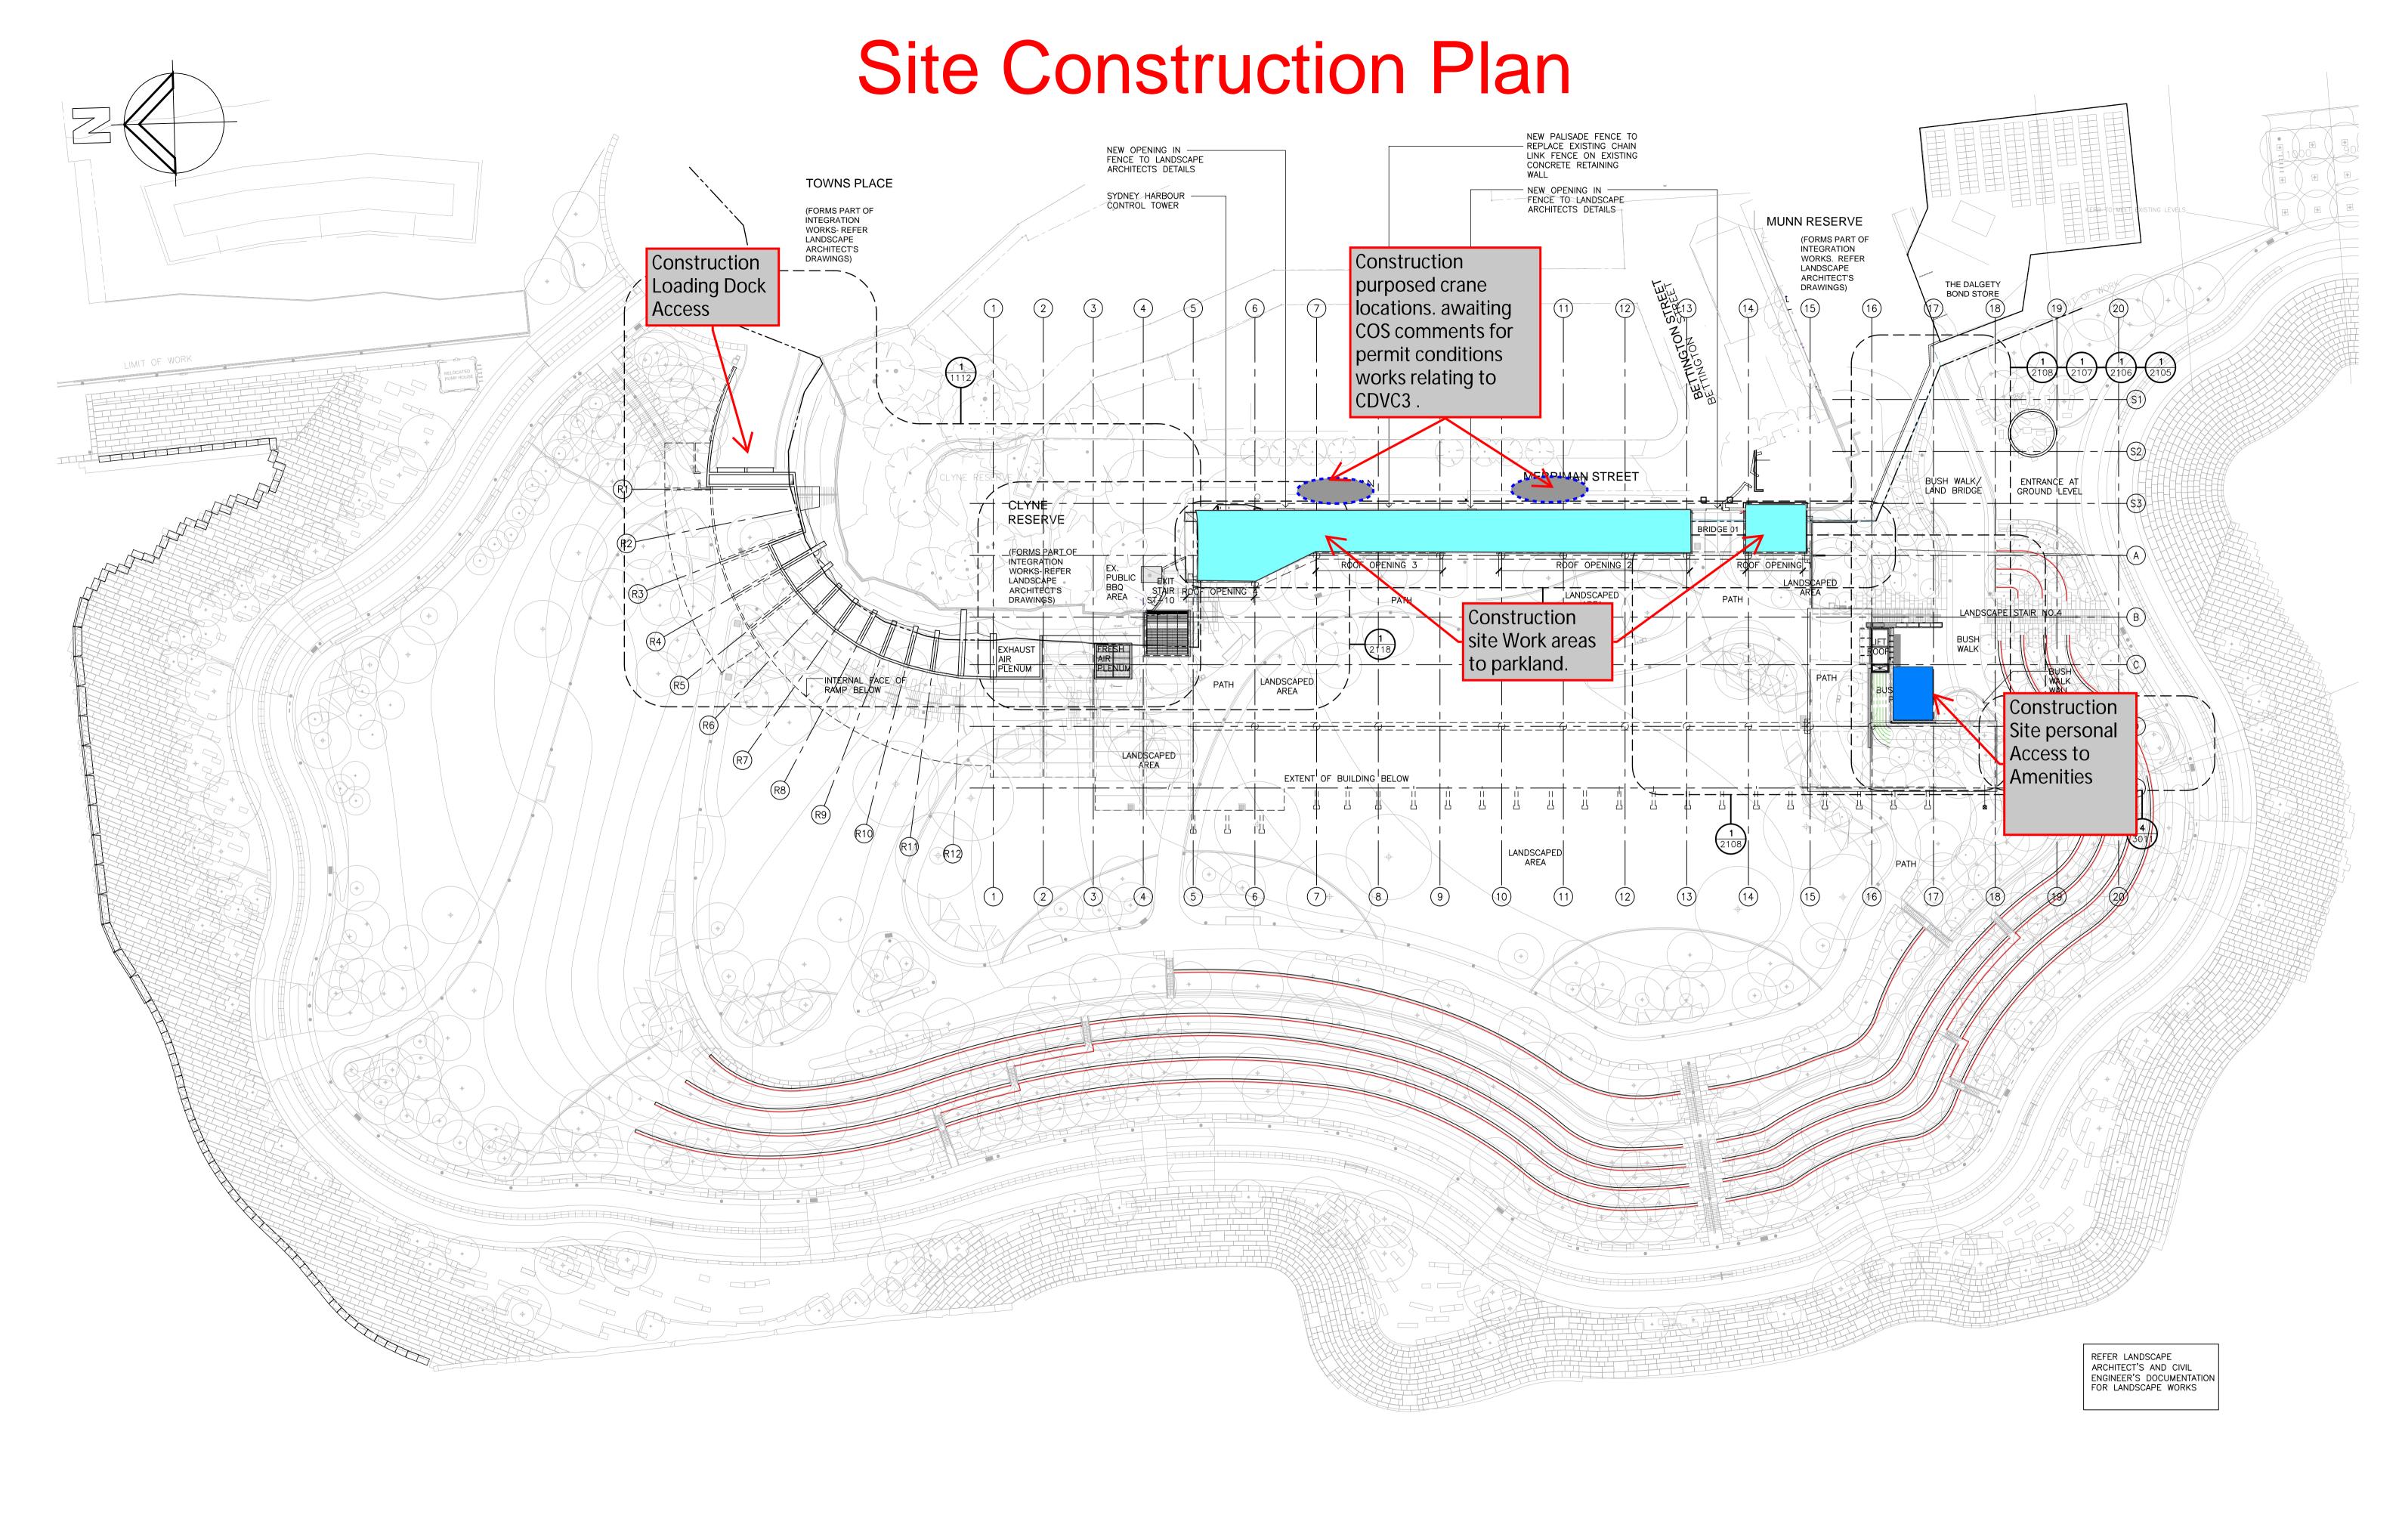

# Ground Floor Temps

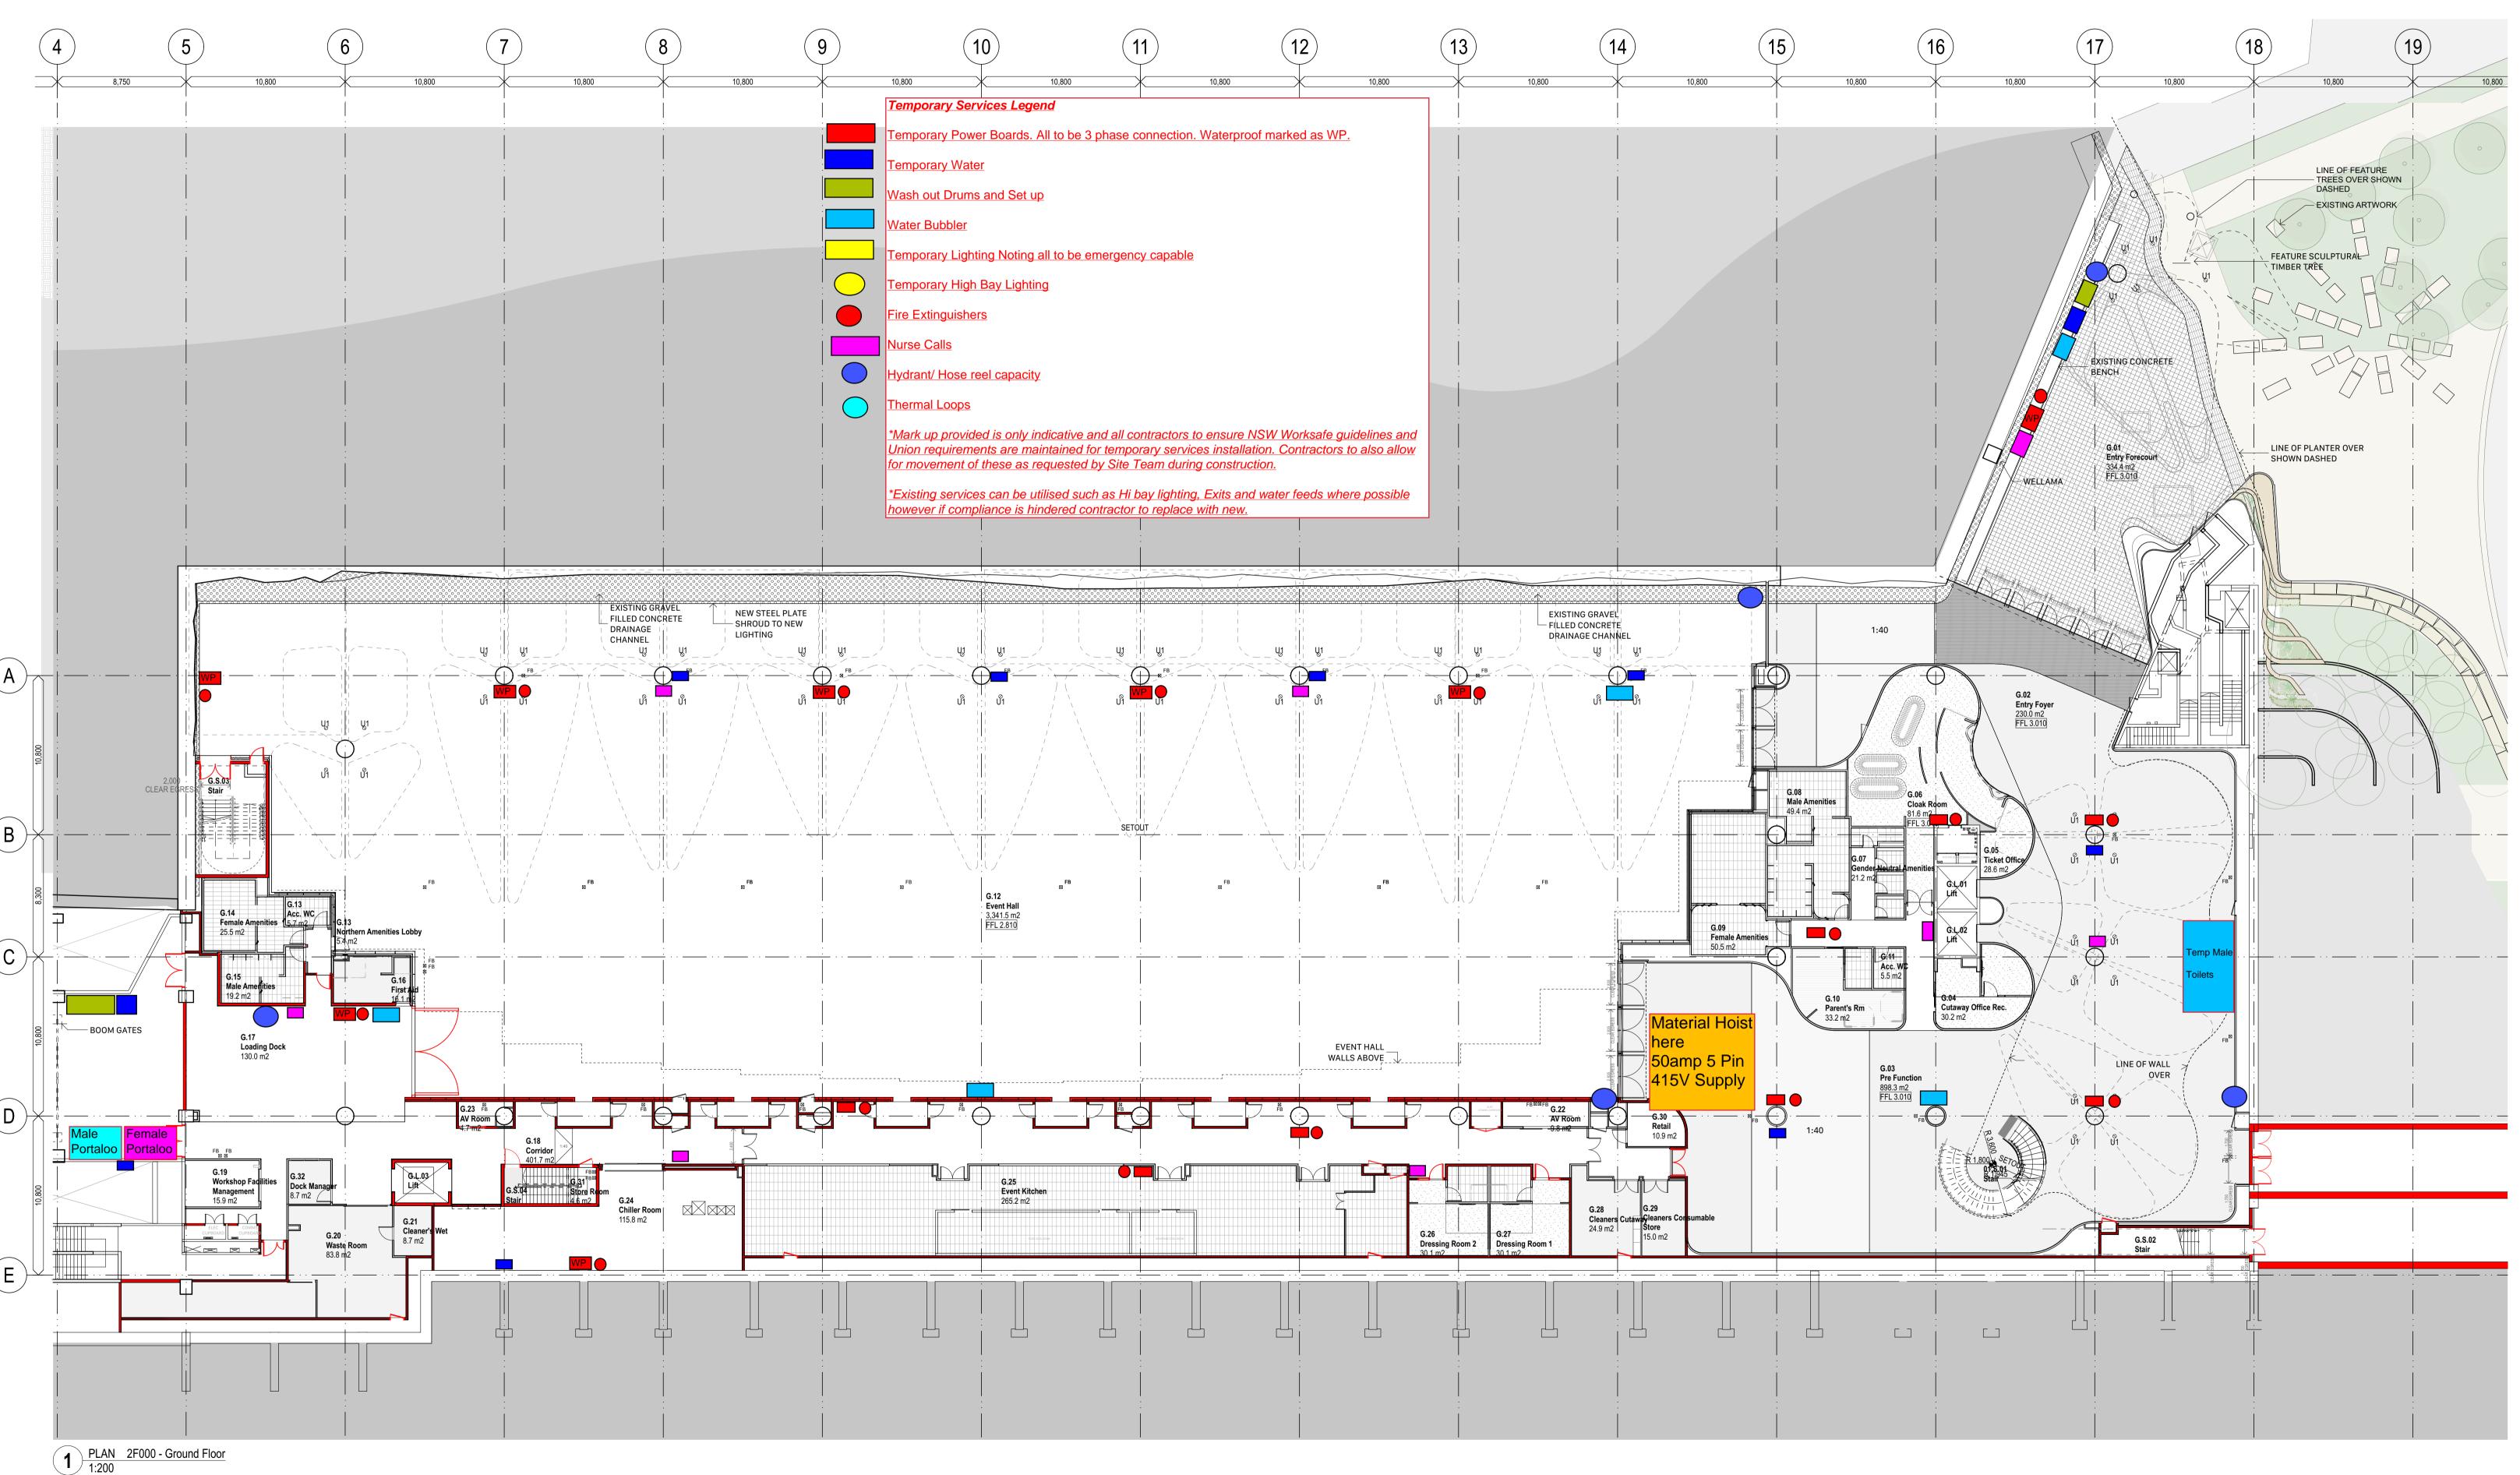




General notes

 All dimensions and existing conditions shall be checked and verified by the contractor before proceeding with the work. All levels relative to 'Australian Height Datum'. Do not scale drawings.

Use figured dimensions only.

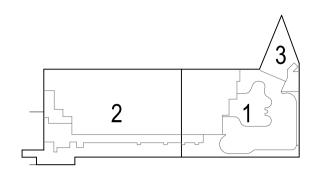

ALL EXISTING WALLS AND COLUMNS ARE NOTED IN BLACK U.N.O.

EXISTING ZONE **NOT** SUBJECT TO MODIFICATIONS 1.5HR\* CLASS 5 COMPARTMENT (COMMERCIAL)

2HR CLASS 7a COMPARTMENT (CARPARK)

GENERALLY 2HR CONSTRUCTION U.N.O.

GENERALLY 2HR CONSTRUCTION U.N.O.

3HR CLASS 6 COMPARTMENT (RETAIL) GENERALLY 3HR CONSTRUCTION U.N.O.

2HR GENERALLY 2HR CONSTRUCTION U.N.O. INCLUDES COMPARTMENTATION OF: - ELECTRICAL SUPPLY SYSTEM - EQUIPMENT REQUIRING FIRE SEPARATION - FIRE ISOLATED STAIRWAYS - FIRE CONTROL ROOM - VENTILATION SHAFTS THROUGH COMPARTMENTS

FIRE RATED LINE (WALLS AND DOORS). REFER TO ZONE FOR FRL

NOTE: Existing walls assumed to match required FRLs. Subcontractors to verify wall thicknesses on site.

180/180/180 Fire Walls and Loadbearing

120/120/120 Fire Walls and Loadbearing elements - /120/120 Non-loadbearing elements

90/90/90 Fire Walls and Loadbearing

■■■■ -/120/30 AUTOMATIC SLIDING FIRE DOOR LIFT DOORS TO ACHIEVE -/60/- FRL AS

PER BCA CLAUSE C3.10 FIRE CURTAIN TO ACHIEVE -/120/- FRL AND SMOKE SEPARATION IN

ACCORDANCE WITH FEBQ v1 ISSUE No

Fire collar, fire damper or fire pillow to maintain the required FRL achieved by concrete slab

> Part of the Building required to be equiped with a Sprinkler protection System as per BCA Clause E1.5 For detailed sprinkler layouts refer to Fire Services engineering drawings

**Designated Egress** 



02 18/5/2023 Issue for 80% Tender 01 18/5/2023 Issue for Coordination Rev Date Description


THE CUTAWAY

Barangaroo NSW 2000 Fire Compartment Plans Ground Floor

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**Project Code** First Issued BCY 18/5/2023 Sheet No.

# Ground Floor RCP Temps



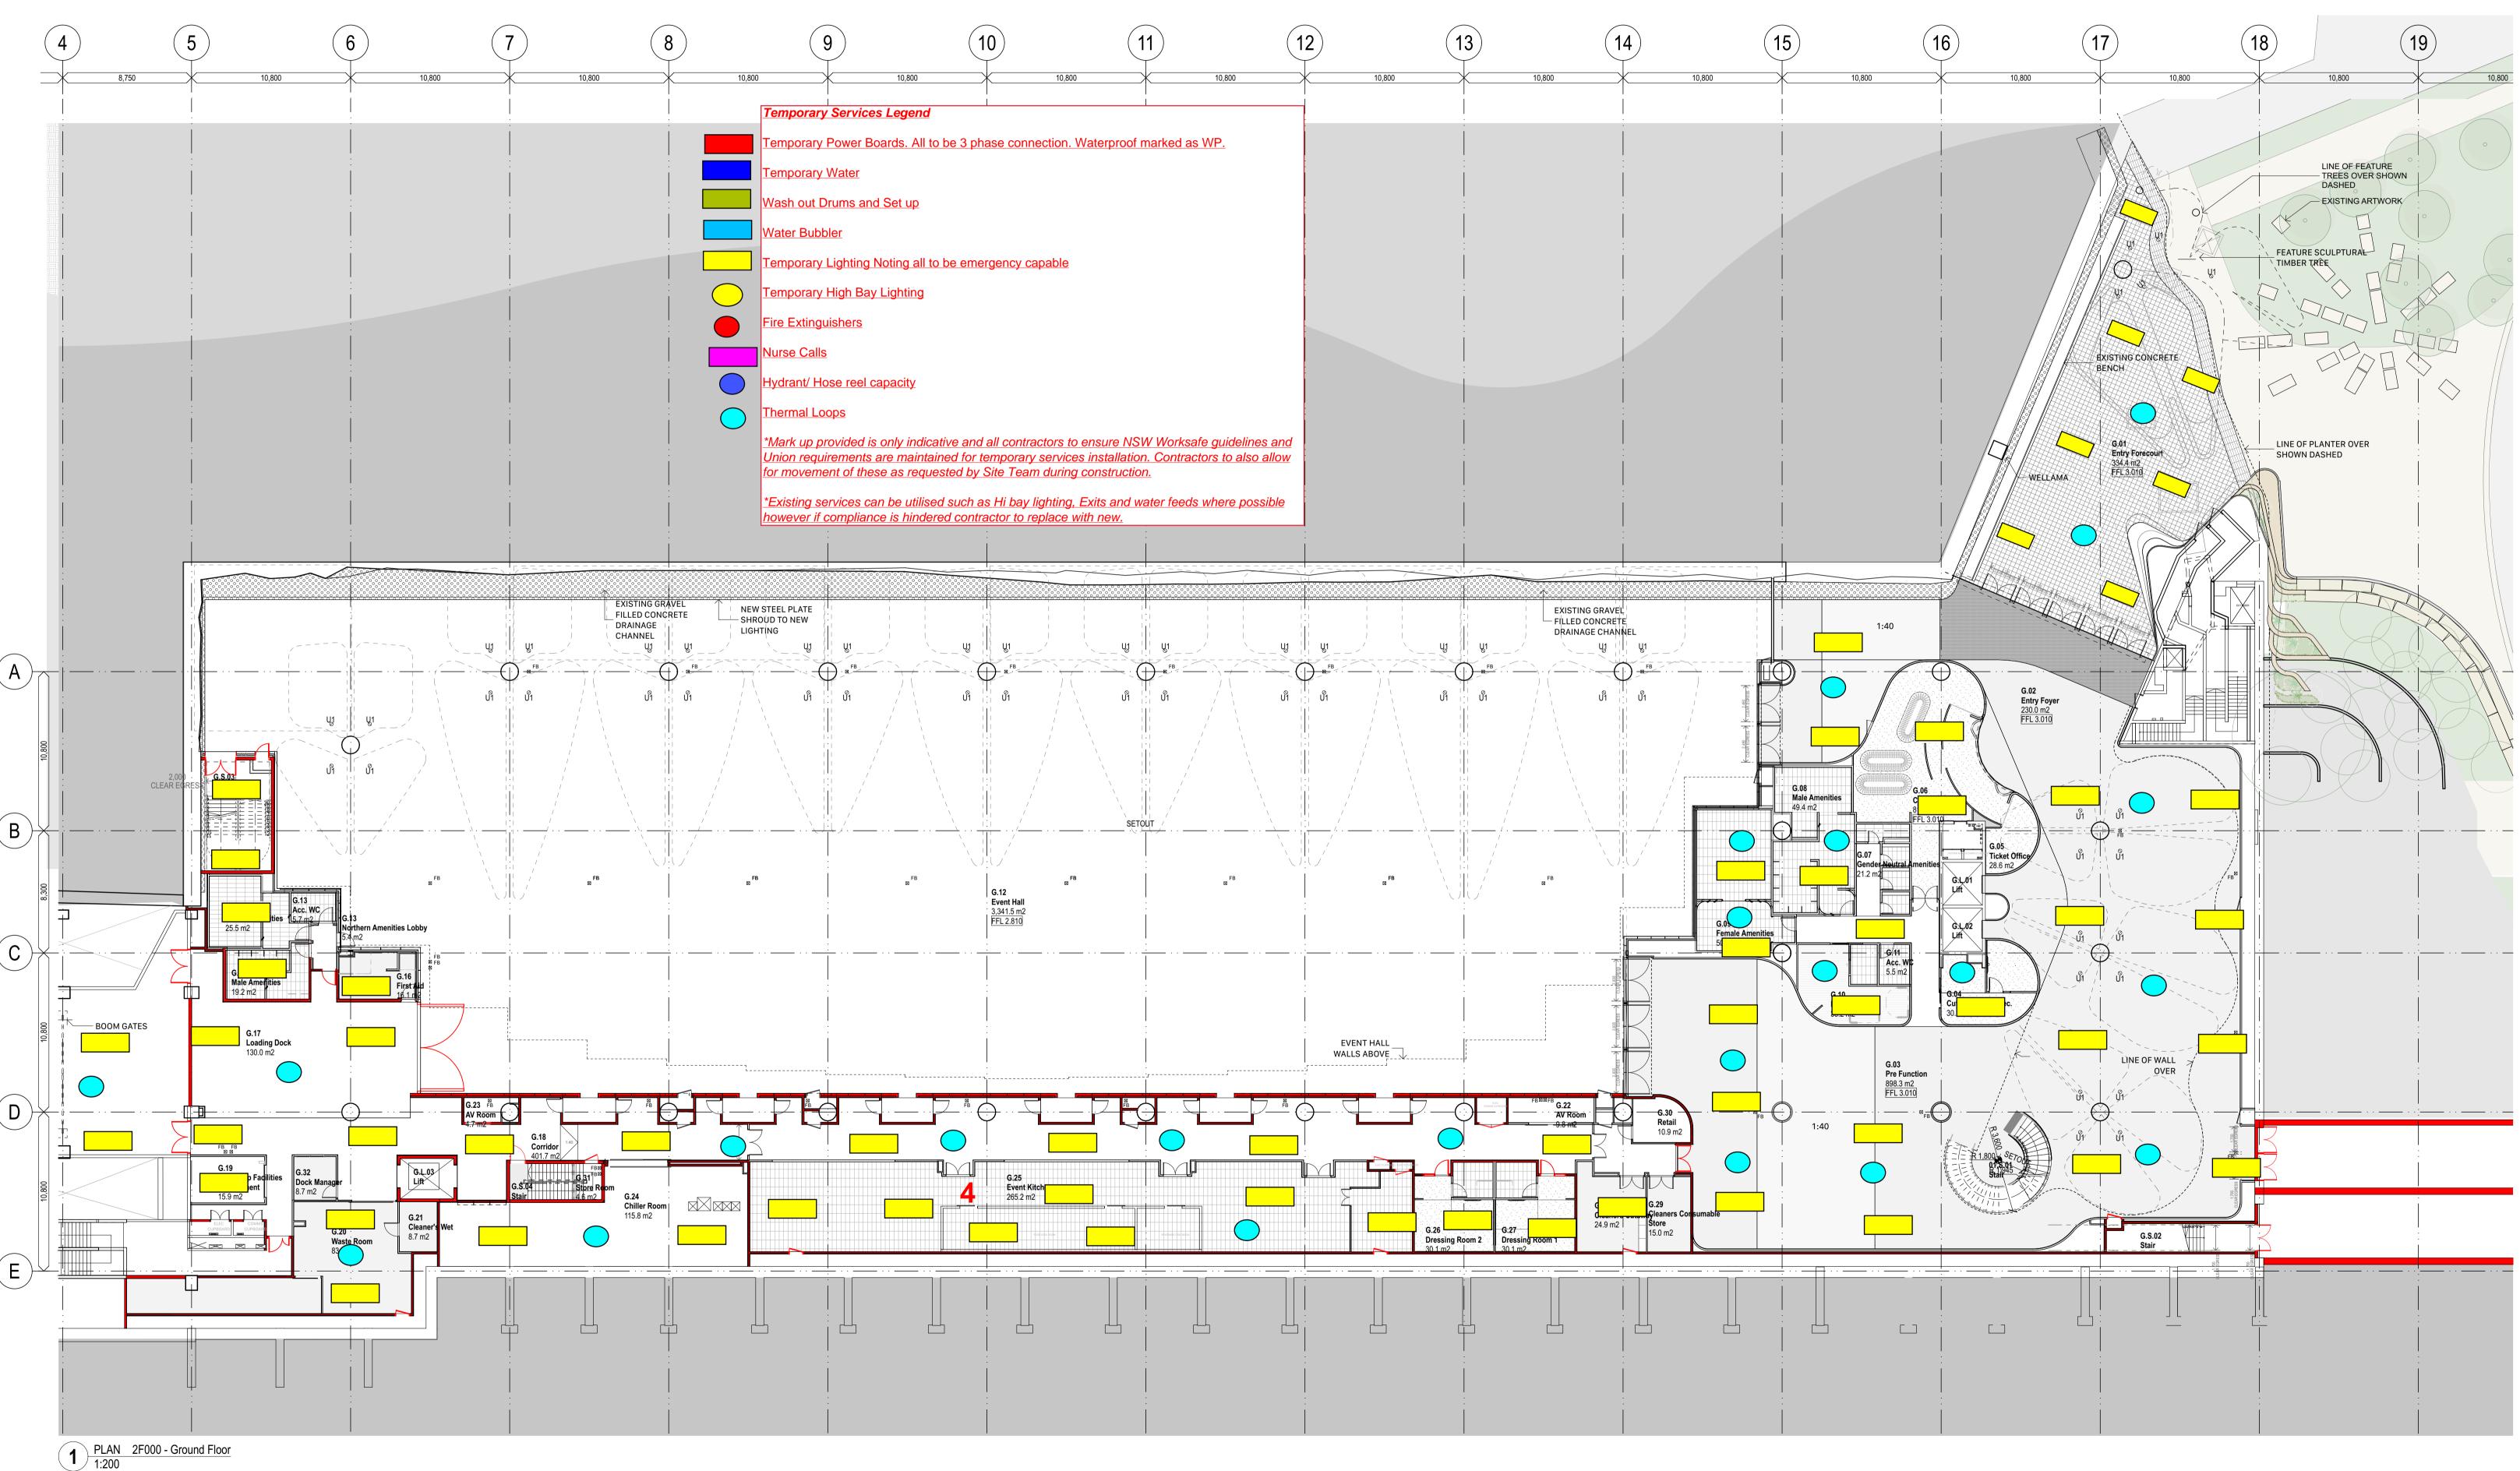


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Legend



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EXISTING ZONE **NOT** SUBJECT TO

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1.5HR\*
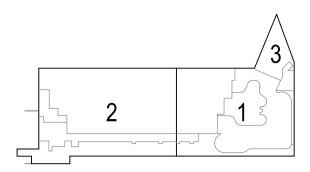
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- LIFT SHAFTS
- FIRE ISOLATED STAIRWAYS
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For detailed sprinkler layouts refer to
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Designated Egress Fire Door



 02
 18/5/2023
 Issue for 80% Tender Documentation
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 01
 18/5/2023
 Issue for Coordination
 CHS

 Rev
 Date
 Description
 By Ch

THE CUTAWAY

1 Merriman Str

Rarangaroo NSW 2000


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Barangaroo NSW 2000

Fire Compartment Plans
Ground Floor

Project Code First Issued
BCY 18/5/2023
Sheet No. Rev

### Level 1 Floor Temps




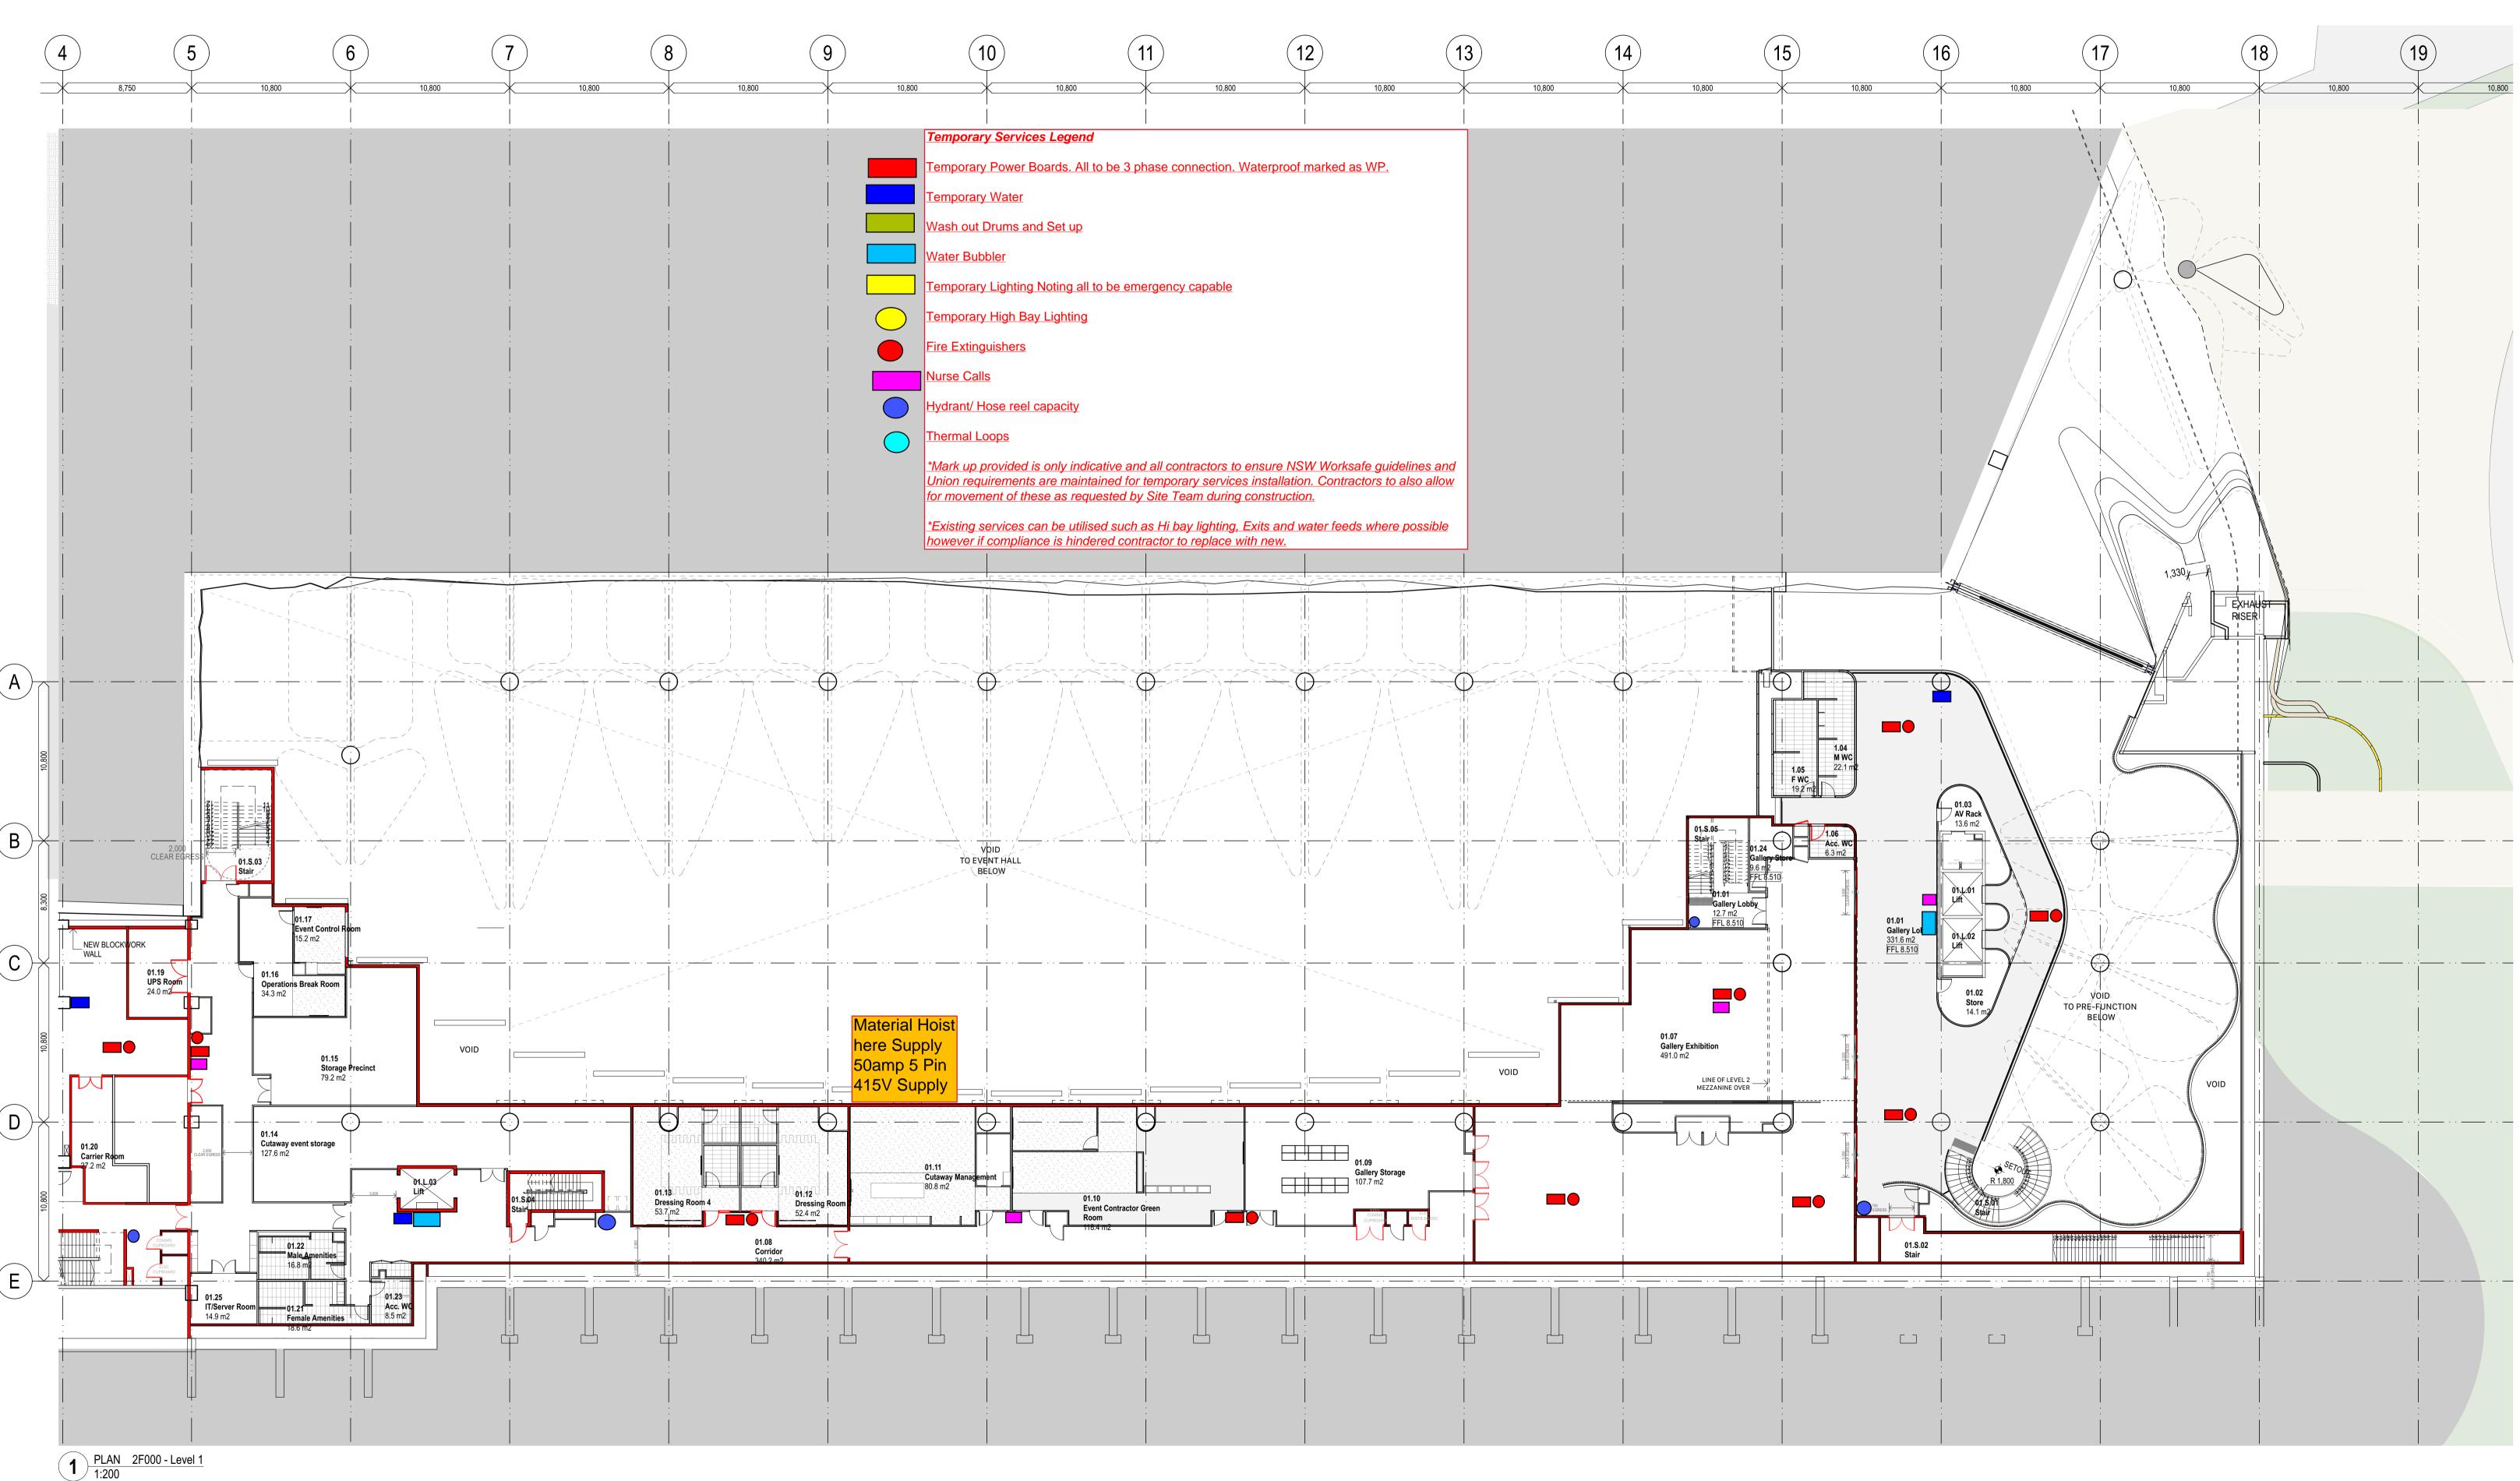

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**Designated Egress** 




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THE CUTAWAY Barangaroo NSW 2000

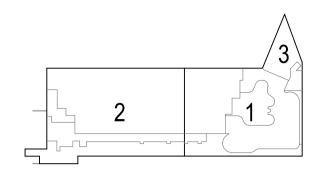Fire Compartment Plans

First Issued **Project Code** 18/5/2023 Sheet No. 2F001

# Level 1 RCP Temps



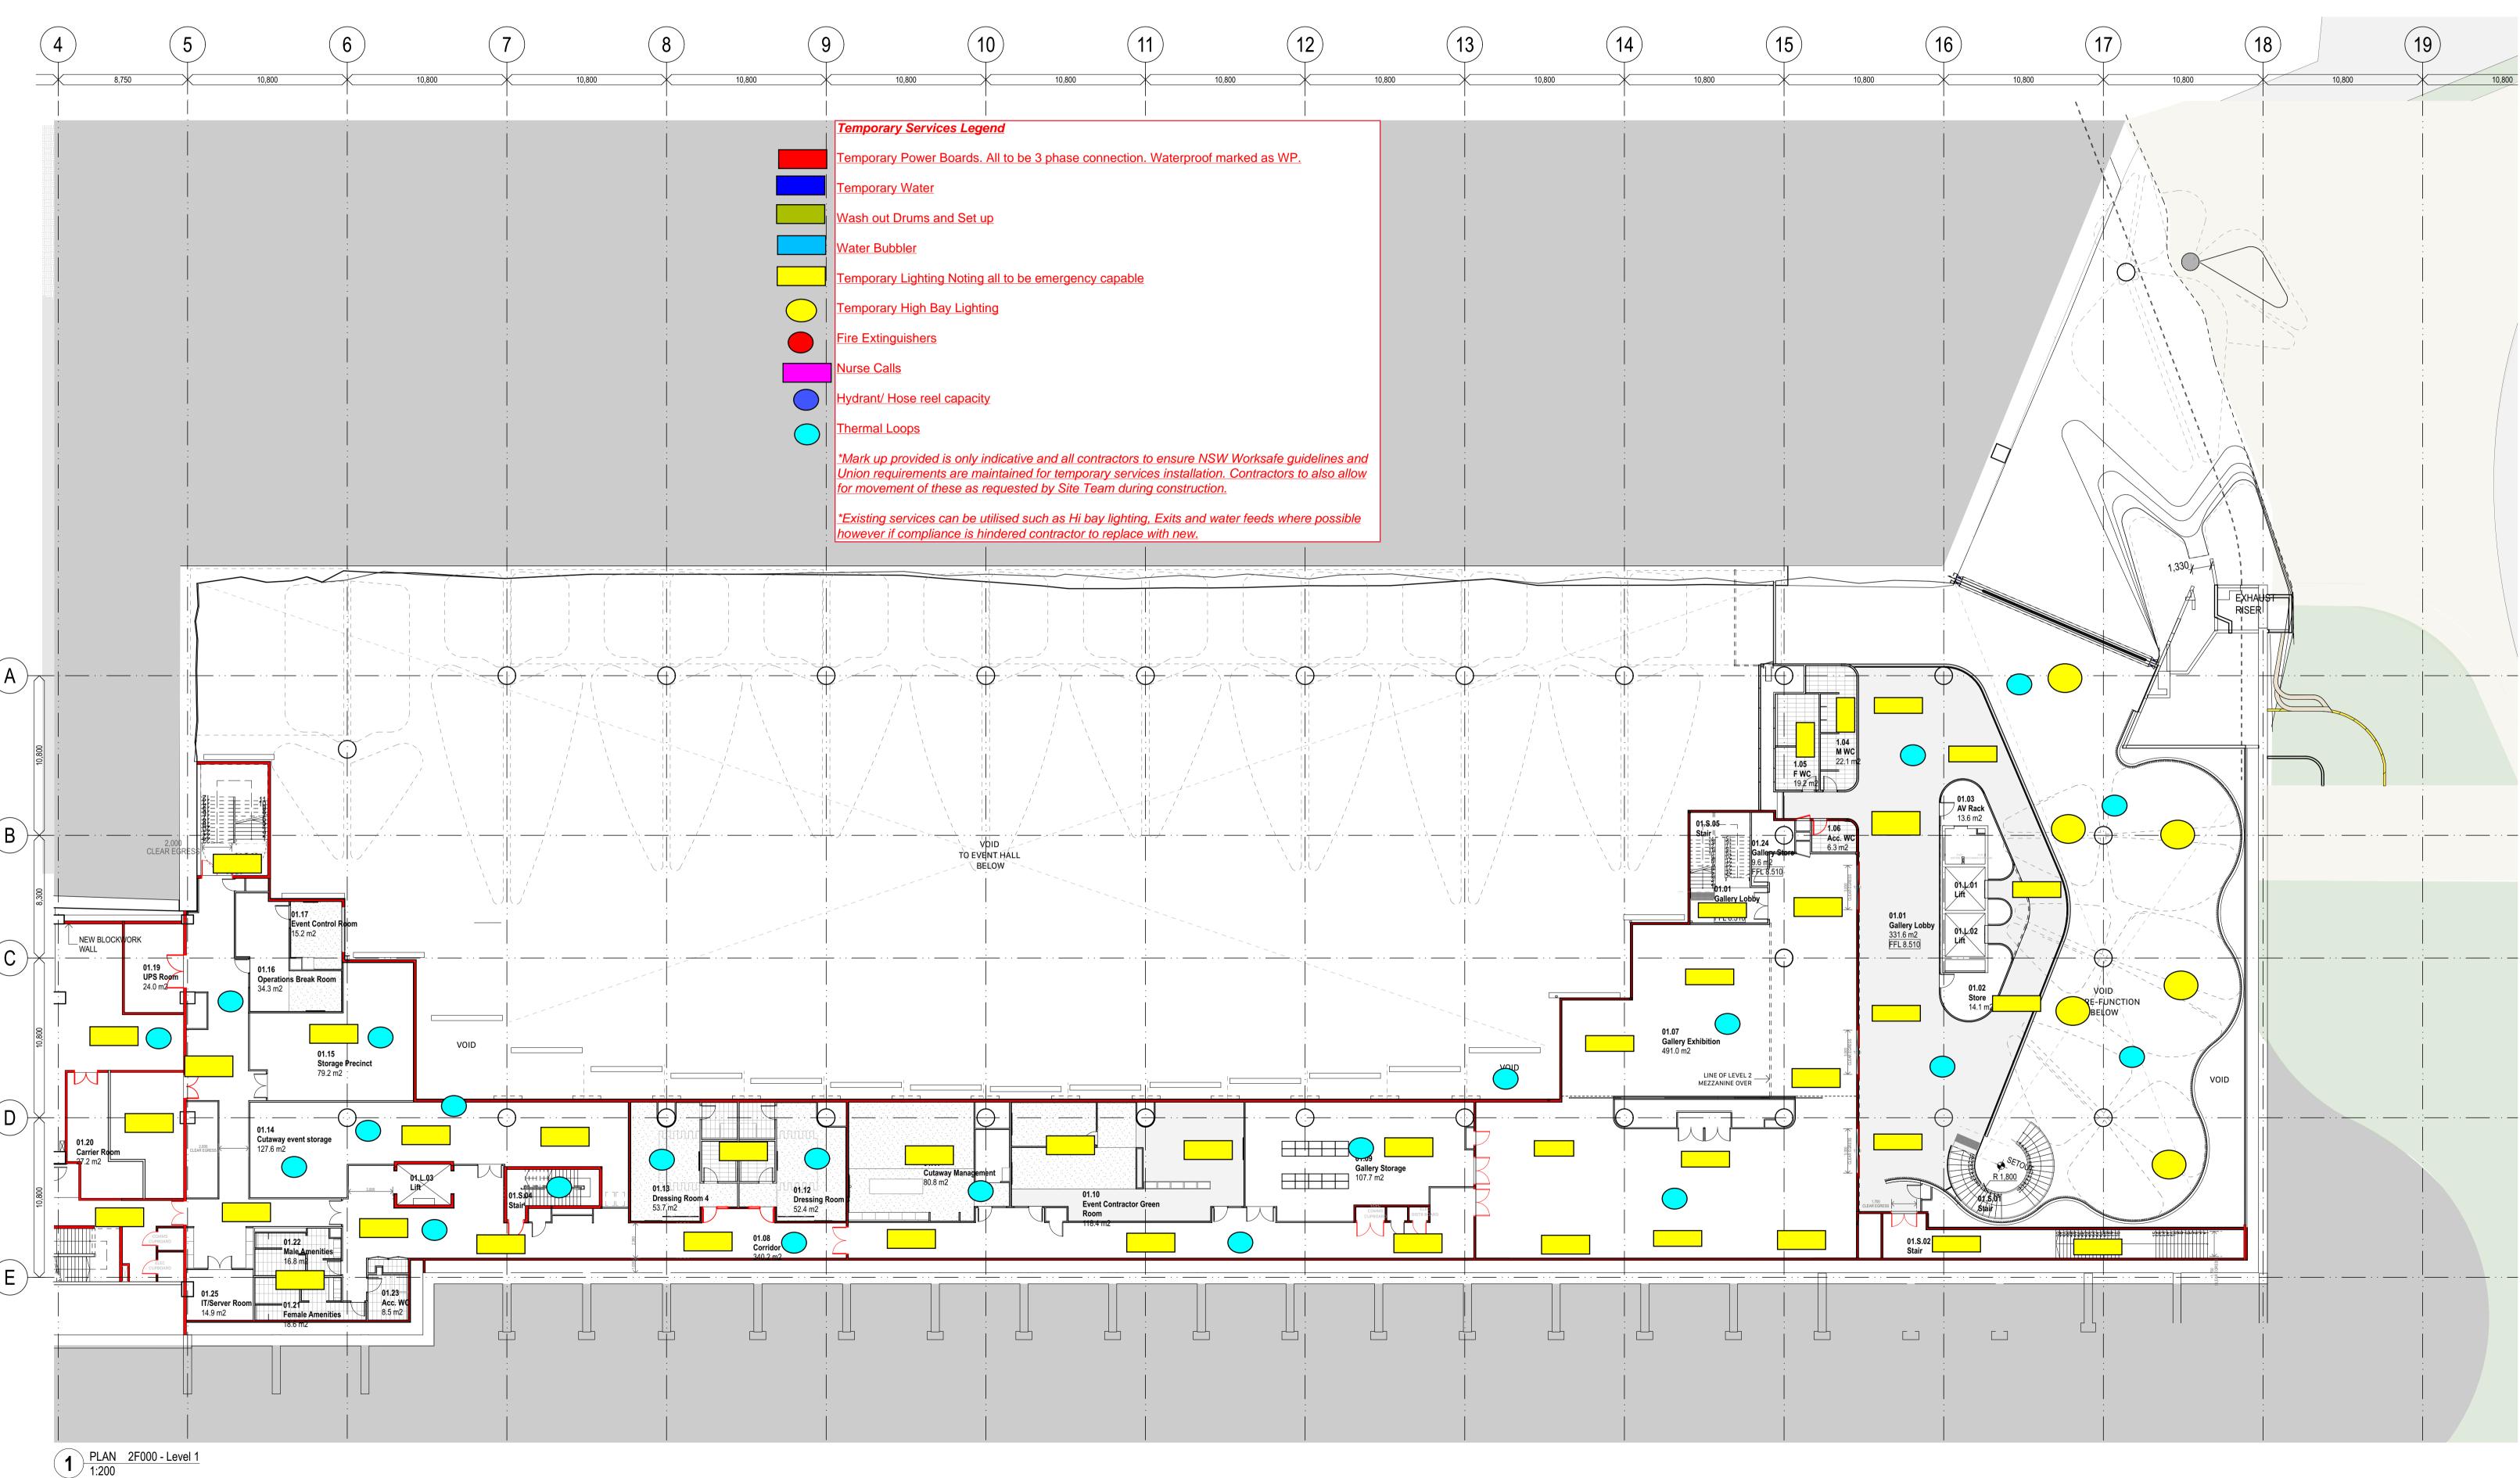


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GENERALLY 2HR CONSTRUCTION U.N.O.

3HR CLASS 6 COMPARTMENT (RETAIL)
GENERALLY 3HR CONSTRUCTION U.N.O.

GENERALLY 2HR CONSTRUCTION U.N.O.
INCLUDES COMPARTMENTATION OF:
- ELECTRICAL SUPPLY SYSTEM
- EQUIPMENT REQUIRING FIRE SEPARATION
- LIFT SHAFTS
- FIRE ISOLATED STAIRWAYS
- FIRE CONTROL ROOM
- VENTILATION SHAFTS THROUGH
COMPARTMENTS

FIRE RATED LINE (WALLS AND DOORS).
REFER TO ZONE FOR FRL

NOTE: Existing walls assumed to match required

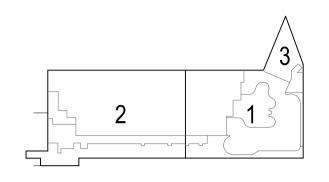**NOTE:** Existing walls assumed to match requirEFRLs. Subcontractors to verify wall thicknesses on site.

FRL DESCRIPTION

180/180/180 Fire Walls and Loadbearing elements

120/120/120 Fire Walls and Loadbearing elements

- /120/120 Non-loadbearing elements

90/90/90 Fire Walls and Loadbearing

AUTOMATIC SLIDING FIRE DOOR

LIFT DOORS TO ACHIEVE -/60/- FRL AS
PER BCA CLAUSE C3.10

FIRE CURTAIN TO ACHIEVE -/120/- FRL AND SMOKE SEPARATION IN ACCORDANCE WITH FEBQ v1 ISSUE No 8

Emergency Lit

Fire collar, fire damper or fire pillow to maintain the required FRL achieved by concrete slab

Part of the Building required to be equiped with a Sprinkler protection System as per BCA Clause E1.5
For detailed sprinkler layouts refer to Fire Services engineering drawings

Designated Egress

Fire Door



 02
 18/5/2023
 Issue for 80% Tender Documentation
 CHS

 01
 18/5/2023
 Issue for Coordination
 CHS

 Rev
 Date
 Description
 By Ch

THE CUTAWAY

1 Merriman Str

Barangaroo NSW 2000


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Barangaroo NSW 2000

Fire Compartment Plans

Project Code First Issued
BCY 18/5/2023
Sheet No. Rev

### Level 2 Floor Temps



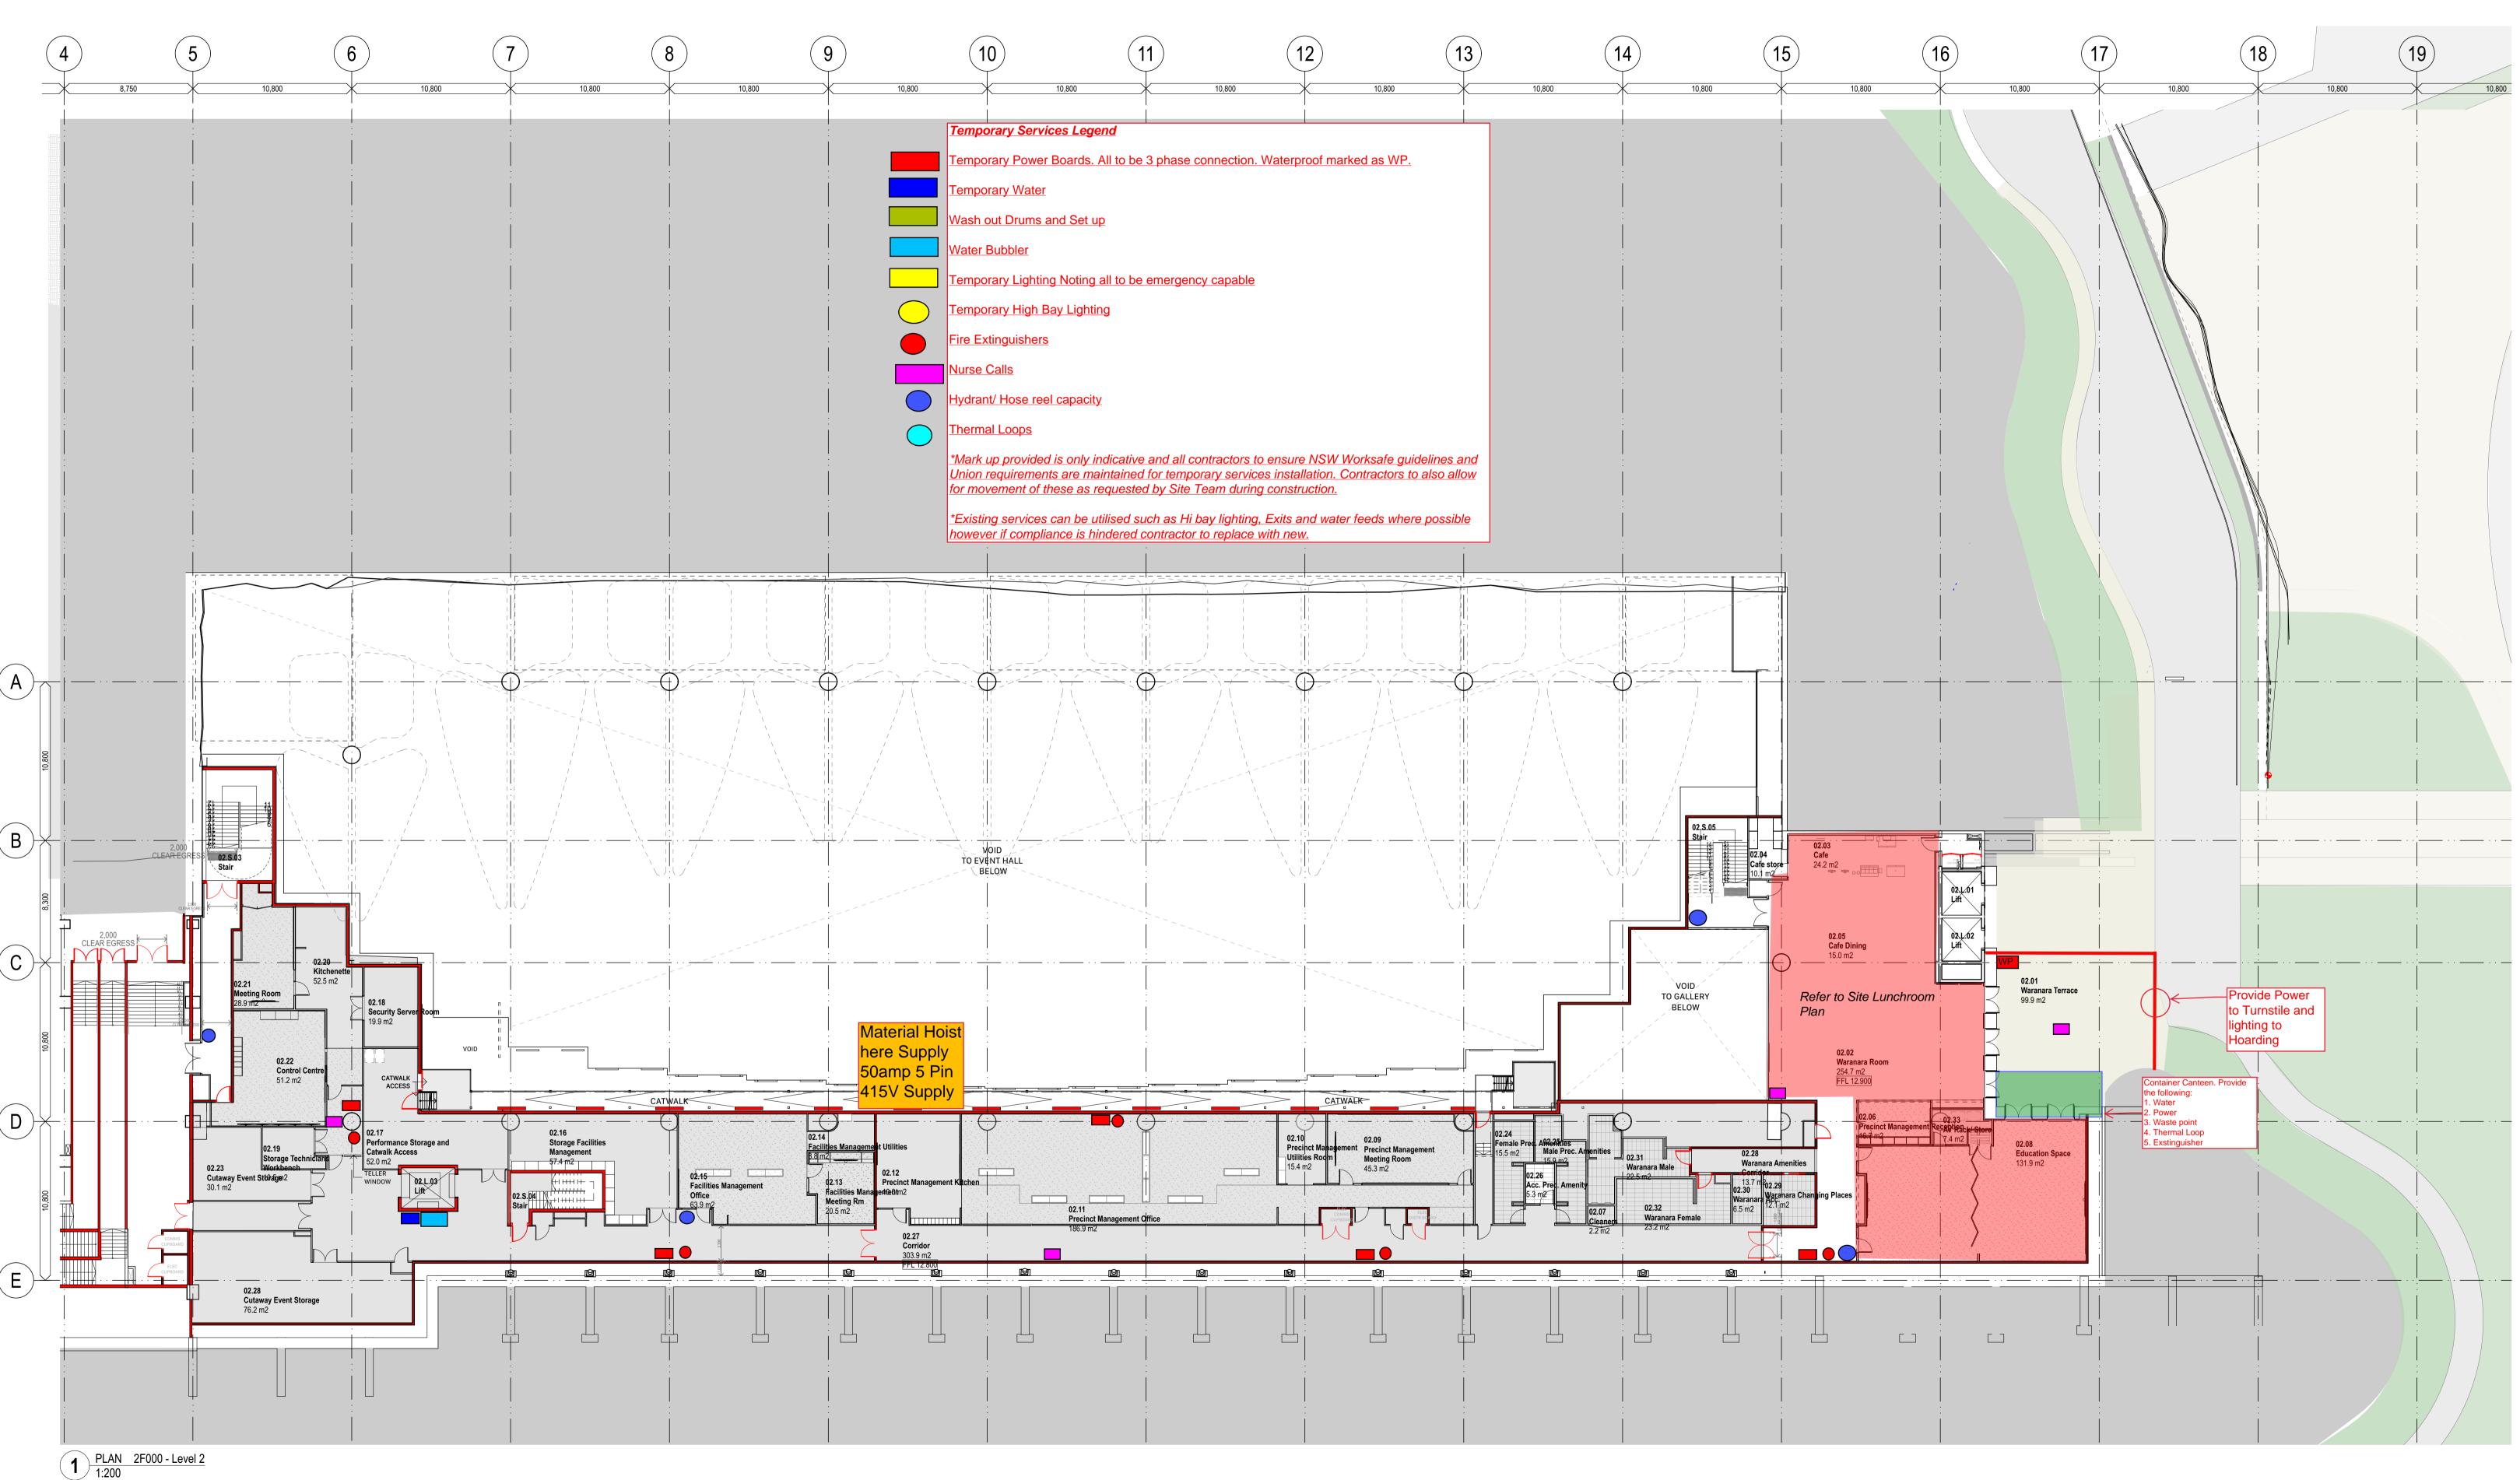


2 5 10m

### General notes

All dimensions and existing conditions shall be checked and verified by the contractor before proceeding with the work.
All levels relative to 'Australian Height Datum'.
Do not scale drawings.
Use figured dimensions only.

### Legen

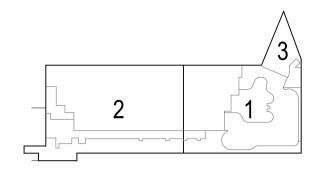

ALL EXISTING WALLS AND COLUMNS ARE NOTED IN BLACK U.N.O.

1.5HR\* CLASS 5 COMPARTMENT (COMMERCIAL)

EXISTING ZONE **NOT** SUBJECT TO MODIFICATIONS

2HR CLASS 7a COMPARTMENT (CARPARK)
GENERALLY 2HR CONSTRUCTION U.N.O.

GENERALLY 2HR CONSTRUCTION U.N.O.

GENERALLY 2HR CONSTRUCTION U.N.O

3HR CLASS 6 COMPARTMENT (RETAIL)

GENERALLY 3HR CONSTRUCTION U.N.O.

2HR GENERALLY 2HR CONSTRUCTION U.N.O.

INCLUDES COMPARTMENTATION OF:
- ELECTRICAL SUPPLY SYSTEM
- EQUIPMENT REQUIRING FIRE SEPARATION
- LIFT SHAFTS
- FIRE ISOLATED STAIRWAYS
- FIRE CONTROL ROOM
- VENTILATION SHAFTS THROUGH
COMPARTMENTS

FIRE RATED LINE (WALLS AND DOORS).
REFER TO ZONE FOR FRL

NOTE: Existing walls assumed to match required

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180/180/180 Fire Walls and Loadbearing

elements

120/120/120 Fire Walls and Loadbearing elements

- /120/120 Non-loadbearing elements

90/90/90 Fire Walls and Loadbearing

elements

AUTOMATIC SLIDING FIRE DOOR

LIFT DOORS TO ACHIEVE -/60/- FRL AS
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Designated Egress

Fire Door



 02
 18/5/2023
 Issue for 80% Tender Documentation
 CHS

 01
 18/5/2023
 Issue for Coordination
 CHS

 Rev
 Date
 Description
 By C

THE CUTAWAY

1 Merriman Str


1 Merriman Str
Barangaroo NSW 2000

Fire Compartment Plans

Sheet No. 2F002

Project Code First Issued
BCY 18/5/2023

# Level 2 RCP Temps

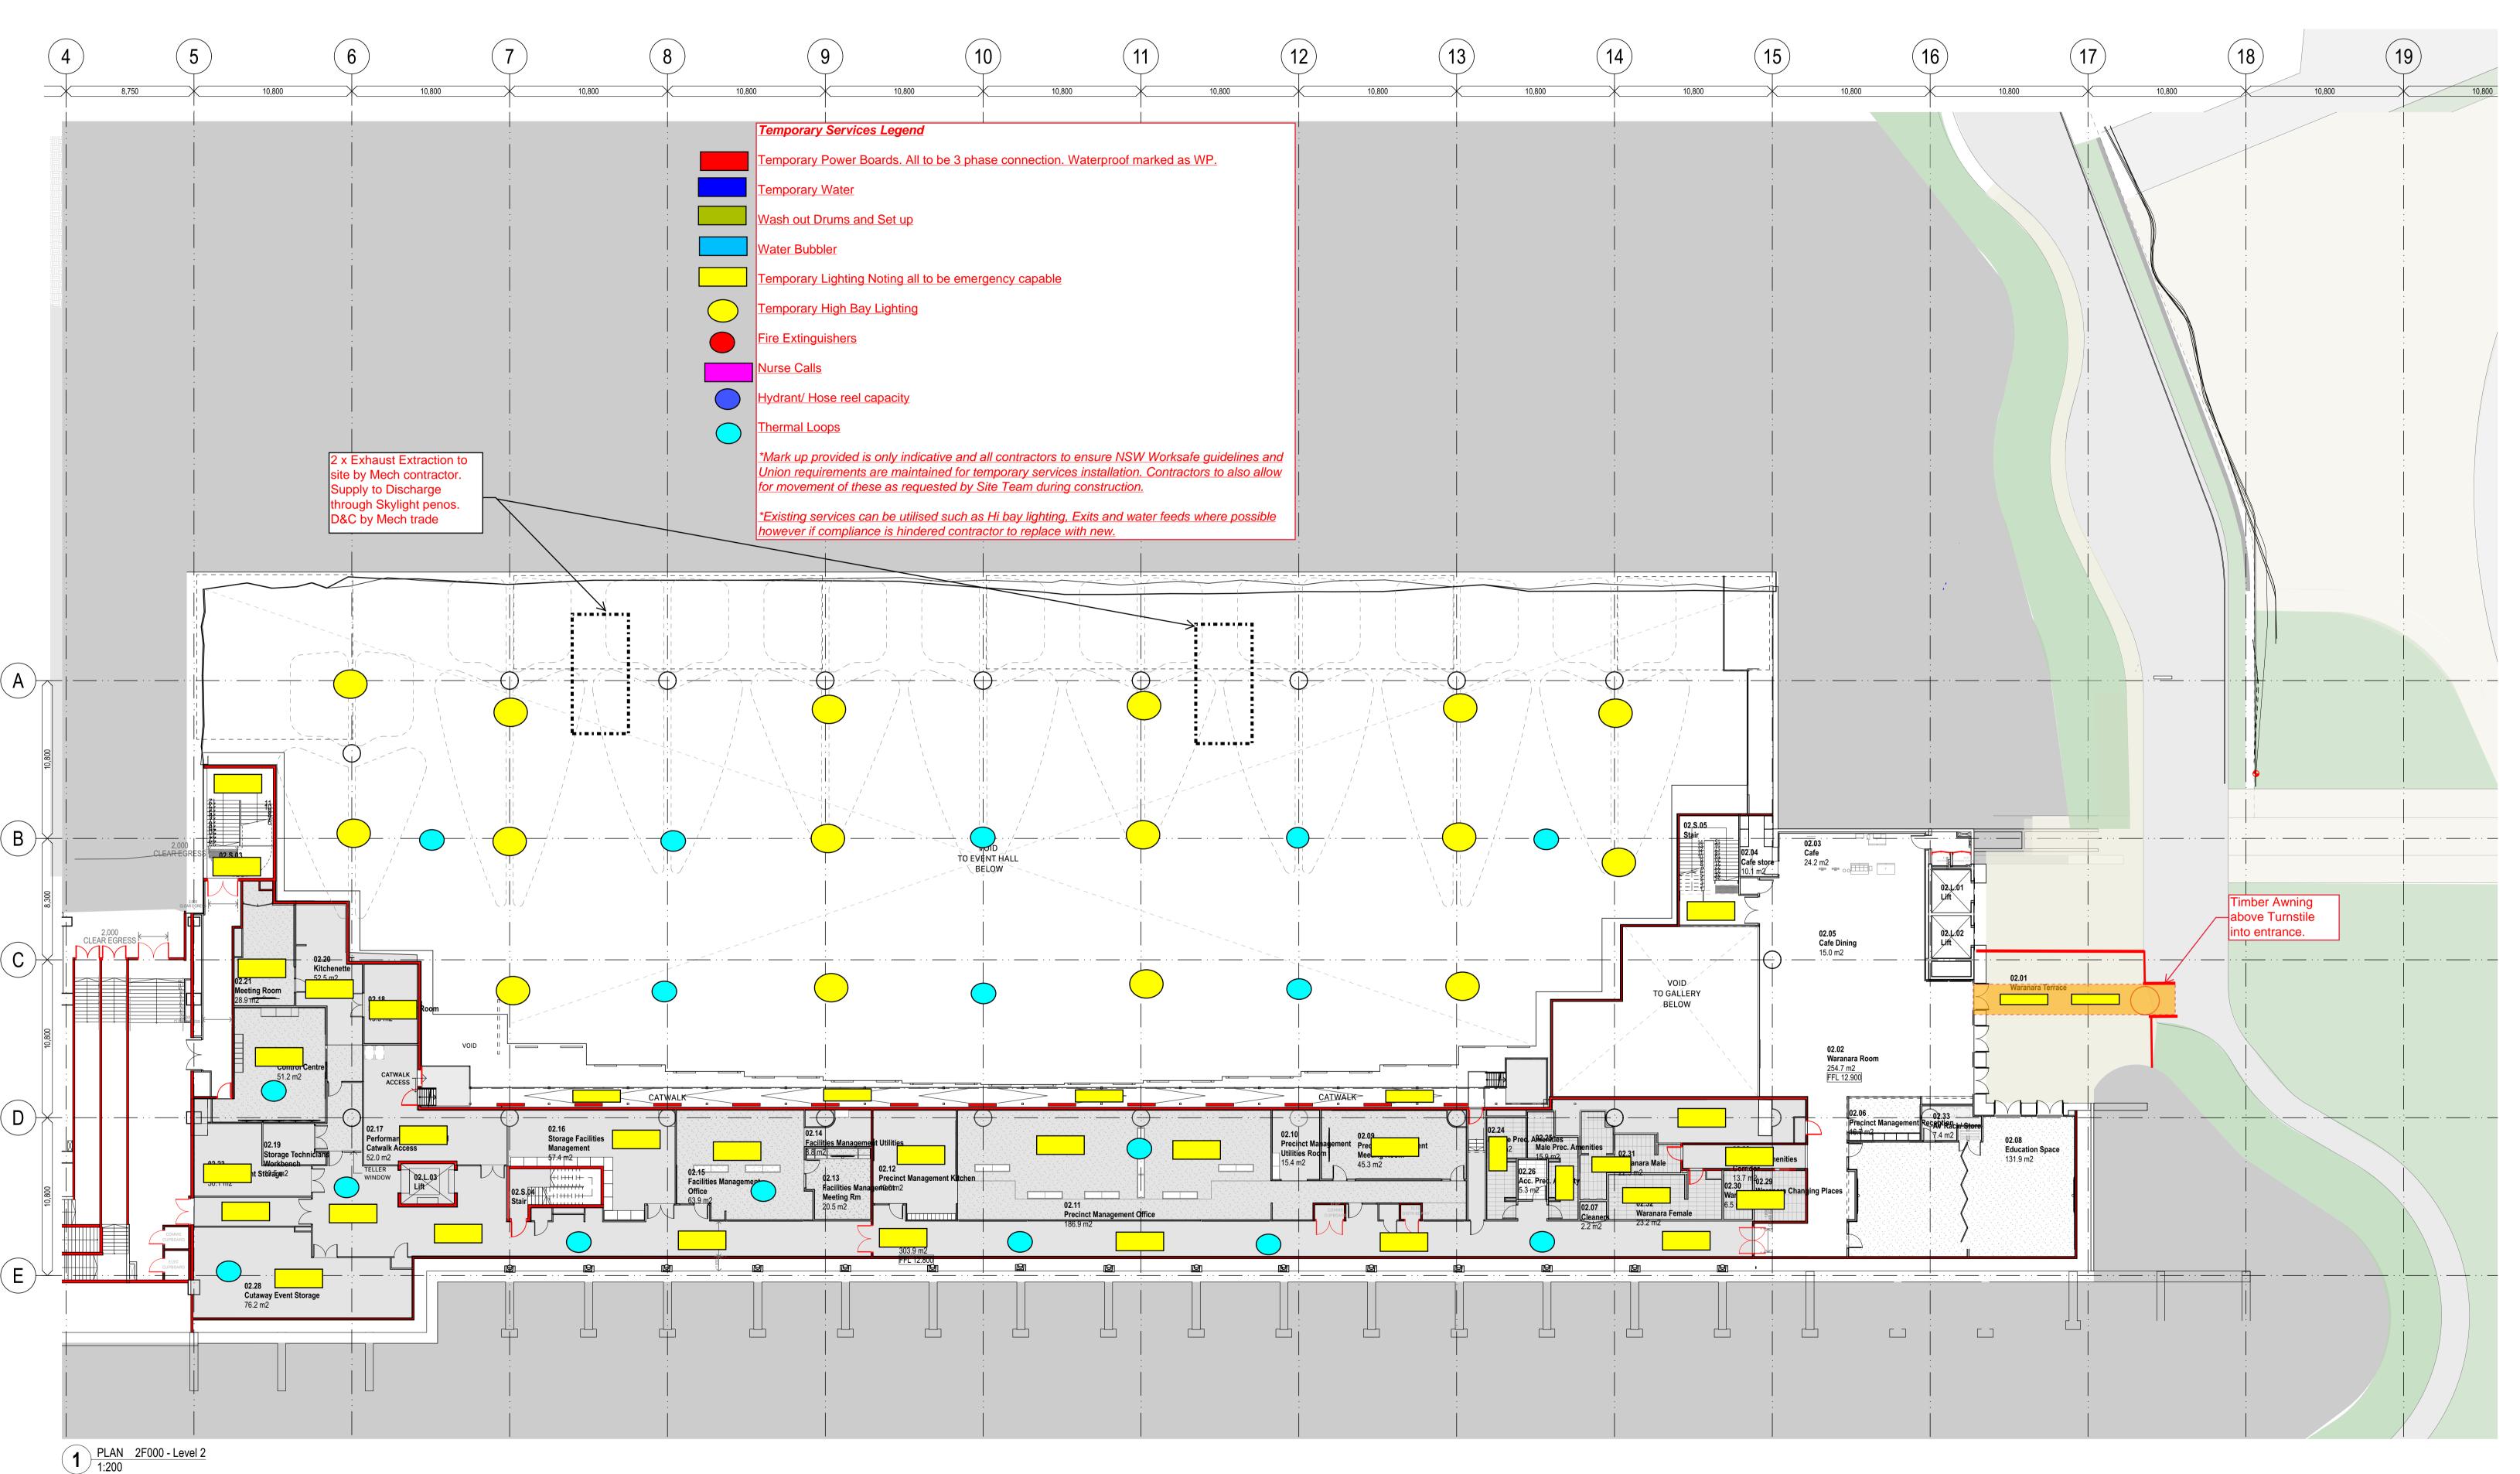




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Use figured dimensions only.

General notes

All dimensions and existing conditions shall be checked and verified by the contractor before proceeding with the work.
All levels relative to 'Australian Height Datum'.
Do not scale drawings.

Legend

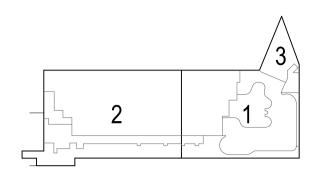

ALL EXISTING WALLS AND COLUMNS ARE NOTED IN BLACK U.N.O.

EXISTING ZONE **NOT** SUBJECT TO

MODIFICATIONS

CLASS 5 COMPARTMENT (COMMERCIAL)
GENERALLY 2HR CONSTRUCTION U.N.O.

2HR CLASS 7a COMPARTMENT (CARPARK)
GENERALLY 2HR CONSTRUCTION U.N.O.

CLASS 6 COMPARTMENT (RETAIL)
GENERALLY 3HR CONSTRUCTION U.N.O.

GENERALLY 2HR CONSTRUCTION U.N.O.
INCLUDES COMPARTMENTATION OF:
- ELECTRICAL SUPPLY SYSTEM
- EQUIPMENT REQUIRING FIRE SEPARATION
- LIFT SHAFTS
- FIRE ISOLATED STAIRWAYS
- FIRE CONTROL ROOM
- VENTILATION SHAFTS THROUGH
COMPARTMENTS

FIRE RATED LINE (WALLS AND DOORS).
REFER TO ZONE FOR FRL

**NOTE:** Existing walls assumed to match required FRLs. Subcontractors to verify wall thicknesses on site.

FRL DESCRIPTION

180/180/180 Fire Walls and Loadbearing elements

120/120/120 Fire Walls and Loadbearing elements

- /120/120 Non-loadbearing elements

90/90/90 Fire Walls and Loadbearing

AUTOMATIC SLIDING FIRE DOOR

LIFT DOORS TO ACHIEVE -/60/- FRL AS
PER BCA CLAUSE C3.10

FIRE CURTAIN TO ACHIEVE -/120/- FRL AND SMOKE SEPARATION IN ACCORDANCE WITH FEBQ v1 ISSUE No

8 Emergency Lit

Emergency Lit

Fire collar, fire damper or fire pillow to

Part of the Building required to be equiped with a Sprinkler protection System as per BCA Clause E1.5
For detailed sprinkler layouts refer to

Fire Services engineering drawings

maintain the required FRL achieved by

Designated Egress

Fire Door



 02
 18/5/2023
 Issue for 80% Tender Documentation
 CHS

 01
 18/5/2023
 Issue for Coordination
 CHS

 Rev
 Date
 Description
 By Chk

THE CUTAWAY


1 Merriman Str


1 Merriman Str
Barangaroo NSW 2000

Fire Compartment Plans

Sheet No. 2F002


Project Code First Issued
BCY 18/5/2023

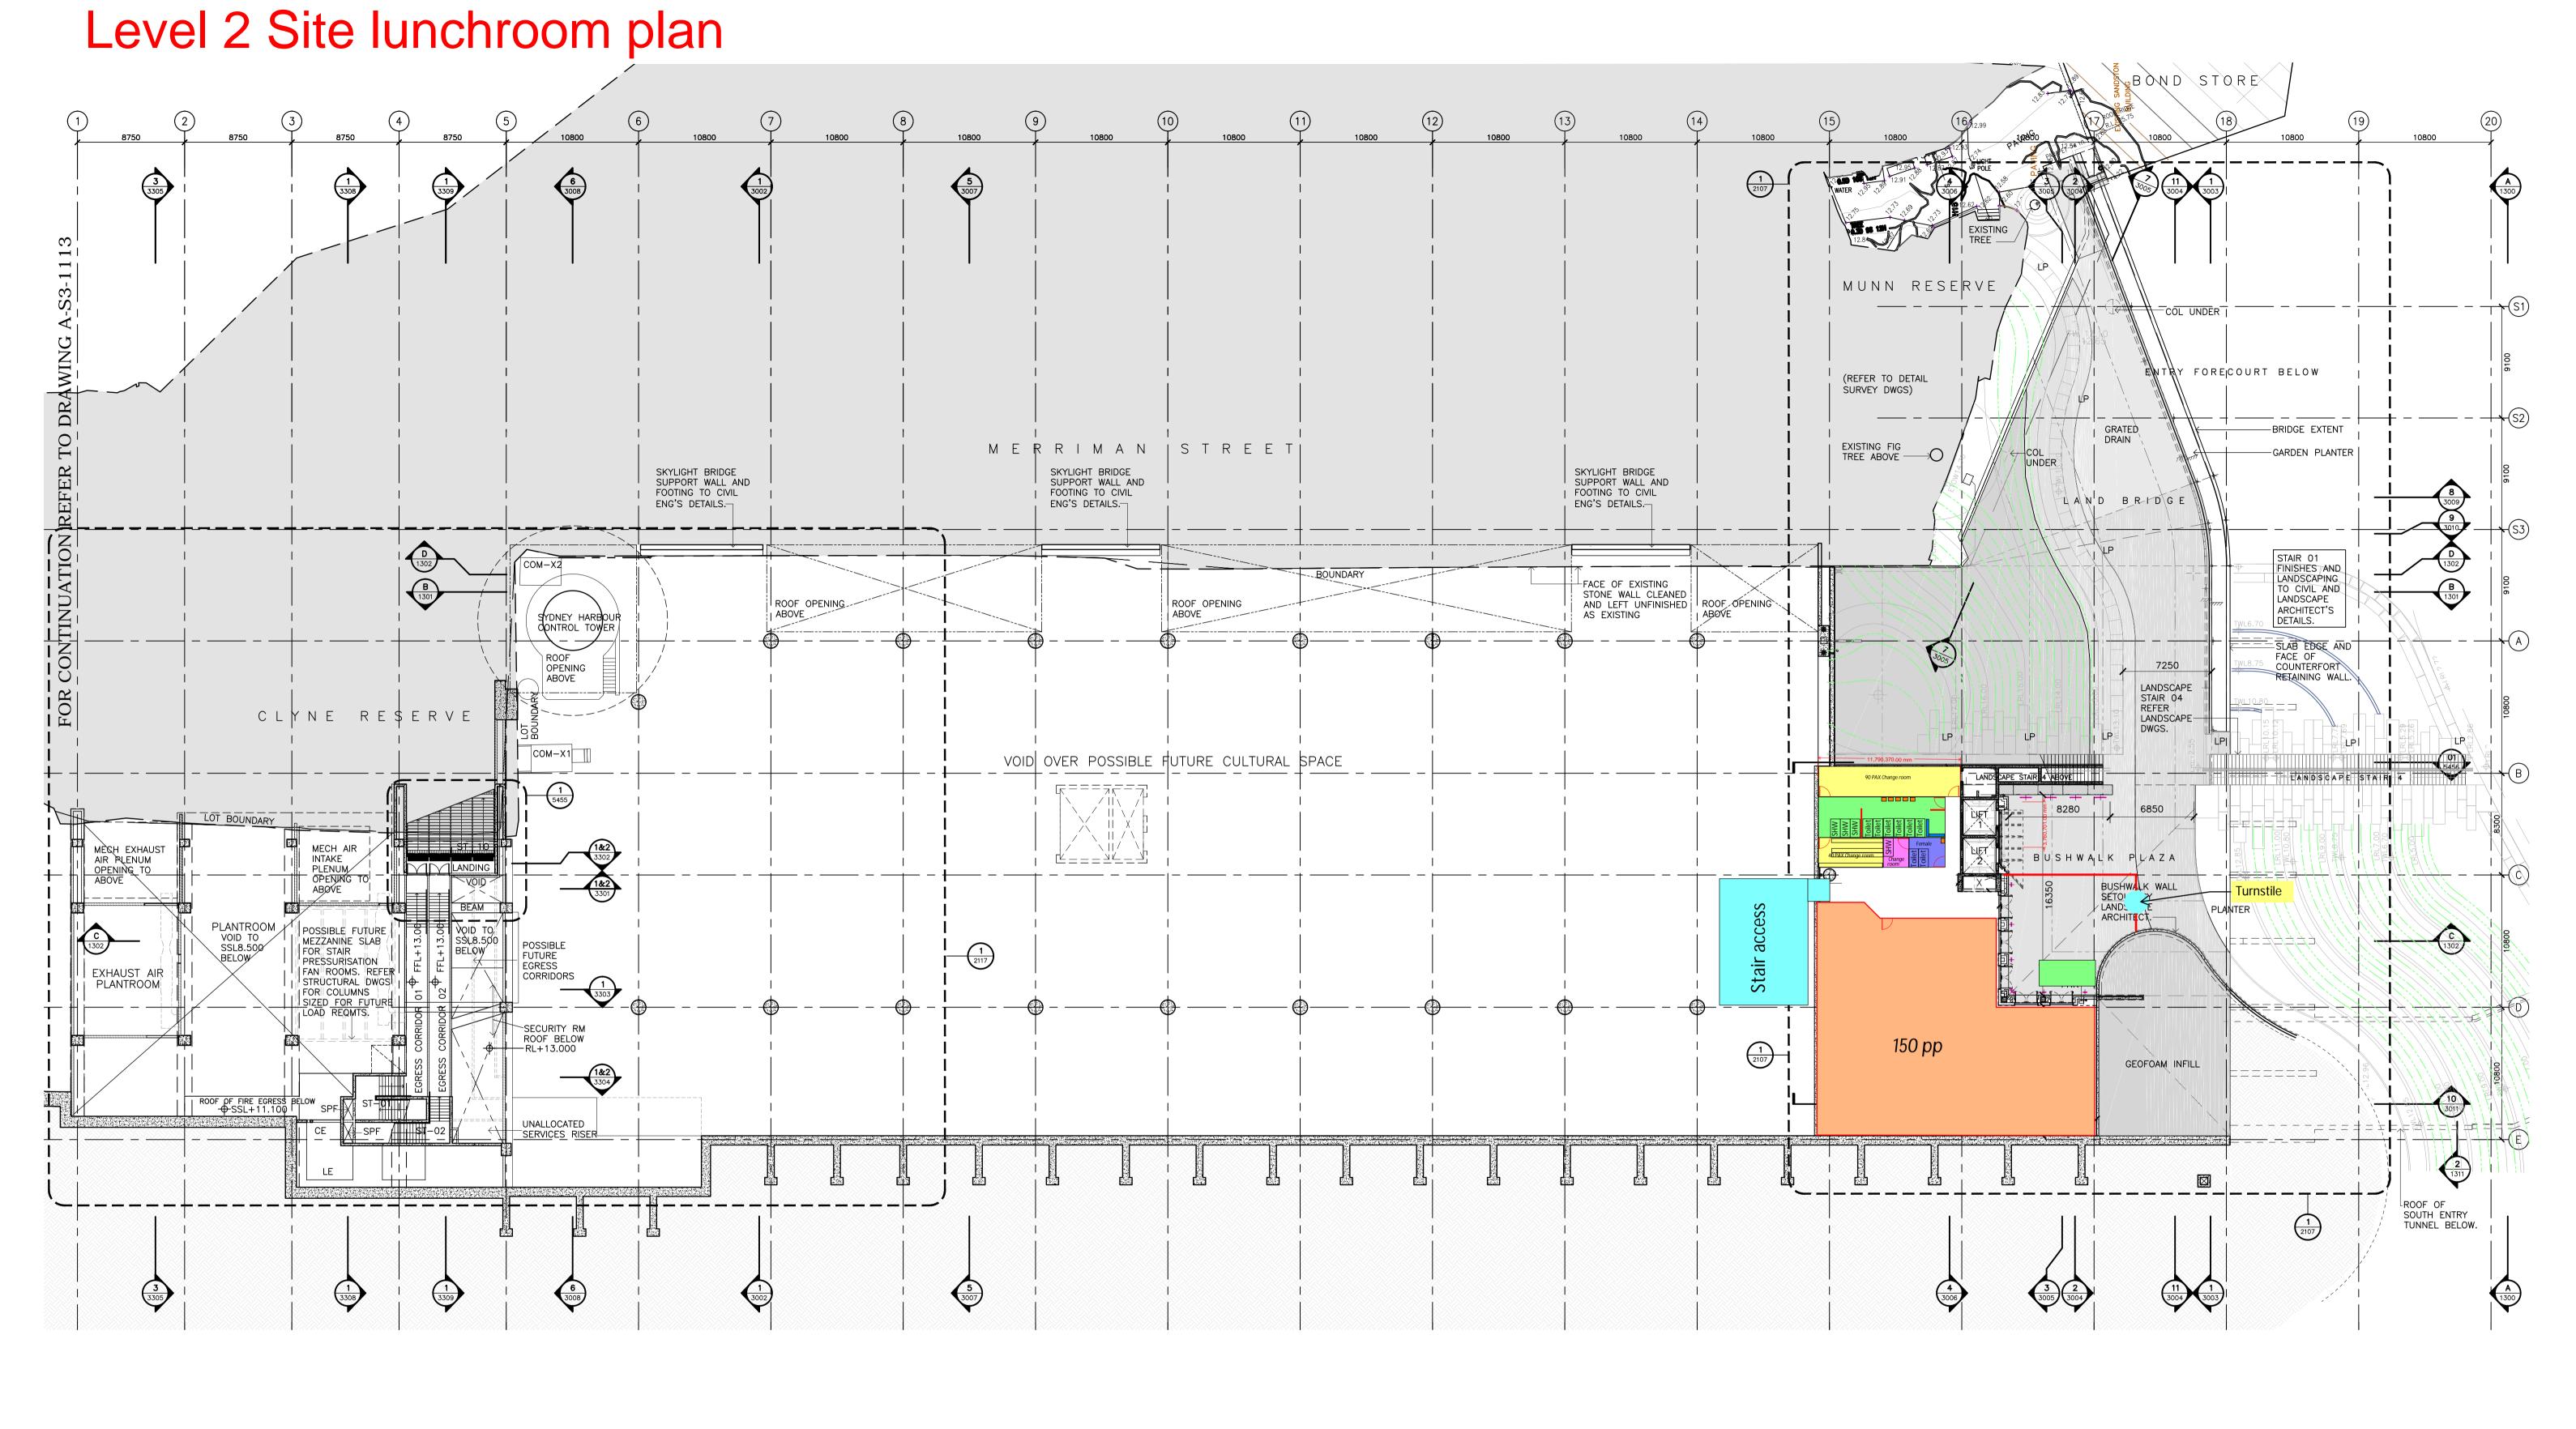

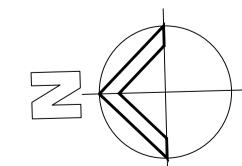





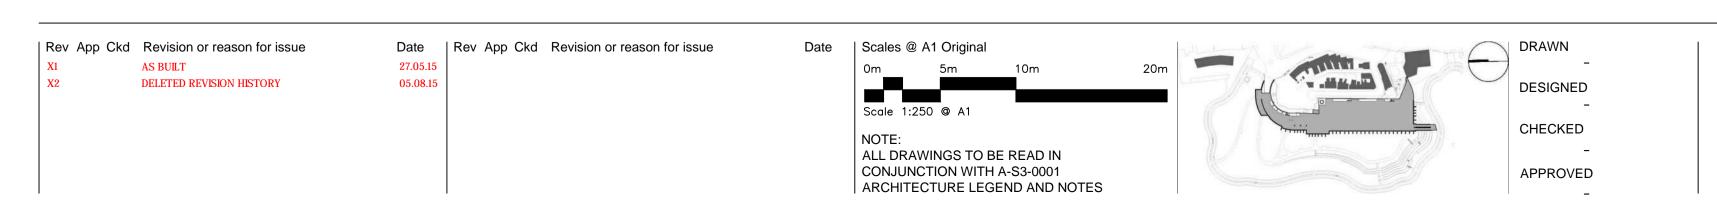








1:250
Project Number Documentation Stage
1244 AS BUILT
Drawing Number Revision
A-S3-1105 X2

### South Street Level Temps

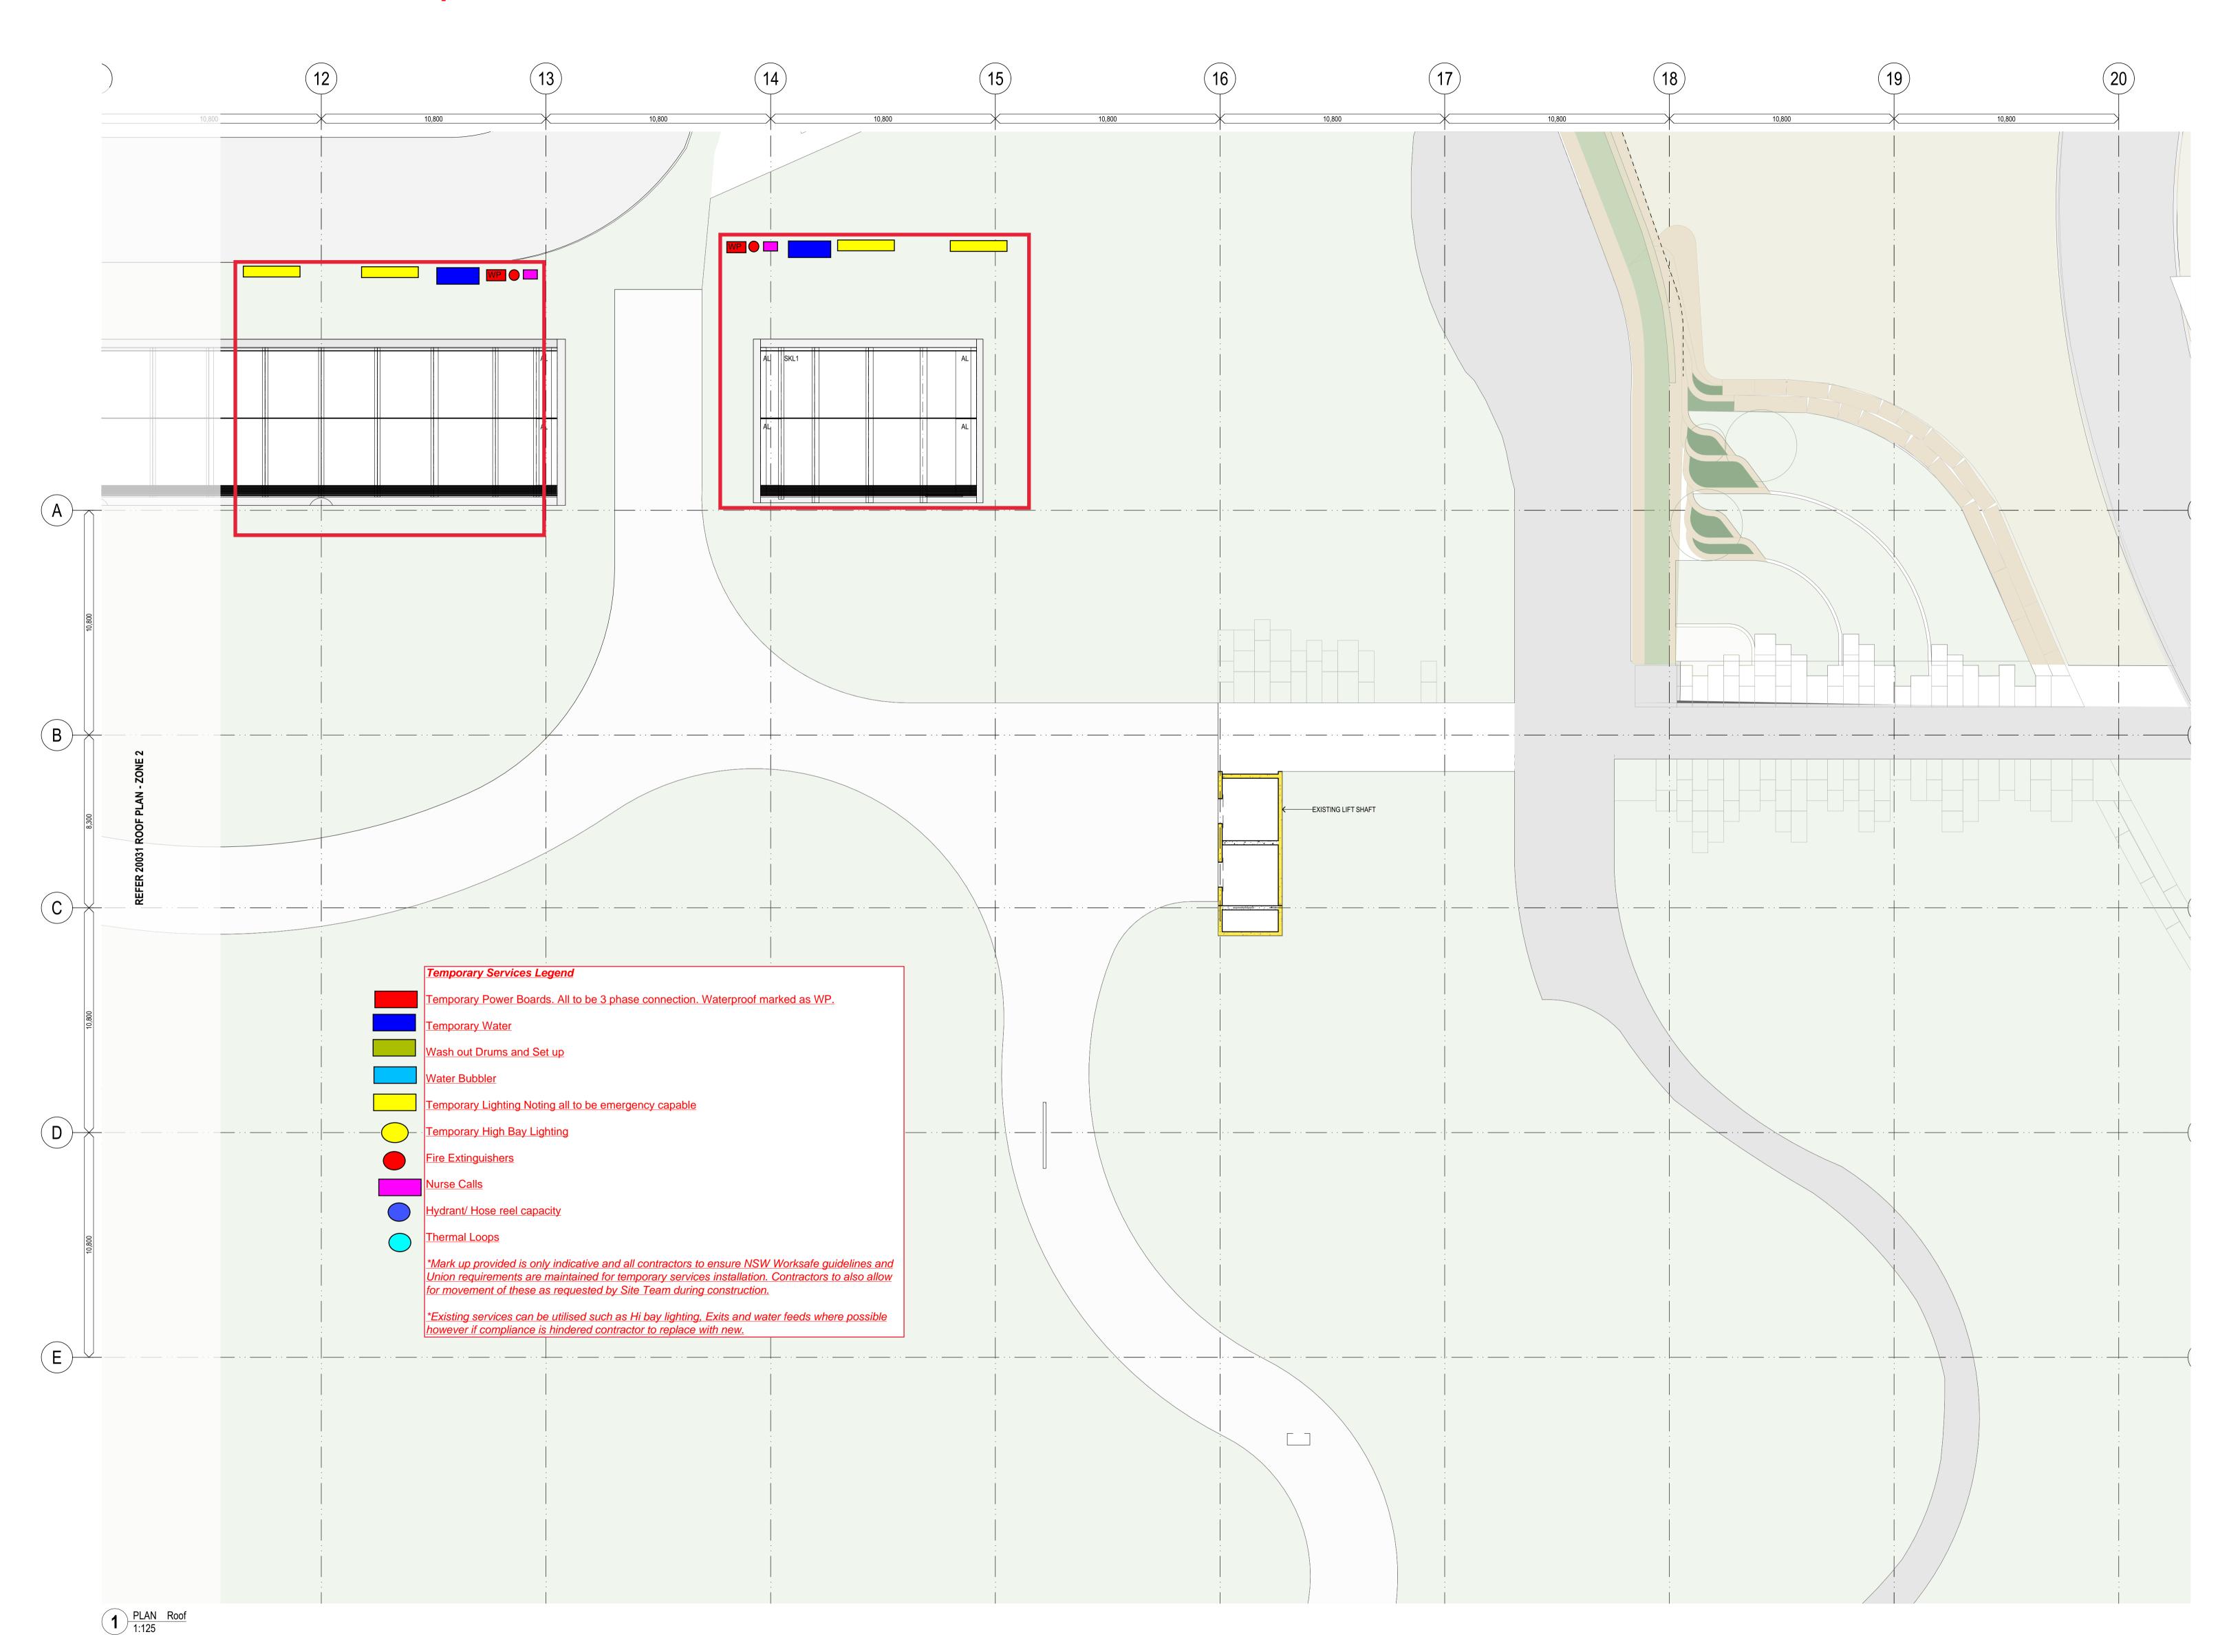





General notes

 All dimensions and existing conditions shall be checked and verified by the contractor before proceeding with the work. All levels relative to 'Australian Height Datum'. Do not scale drawings.

Use figured dimensions only.



DESIGN RESOLUTION - The dimensions shown are general only and are subject to further design resolution. - Ceiling RL (where shown) indicates general ceiling design level only. - Location of plant, equipment and services on drawings is general and indicative,

pipes, flues, aerial, etc. GRAPHIC PRESENTATION - Colours presented on drawings are generic only and indicative of the architectural design intent. Some colour distortion may also occur in the printing process. EXISTING STRUCTURES AND SERVICES

and does not include minor elements, such as vent

- Extent and location of existing structures and services is according to the available information and will all need to be verified on site at - All existing SSL are subject to existing topping thickness confirmation. - All unchanged existing site levels are as per the existing site conditions. - Services slab penetrations shown are indicative and will require further cordination.

**NEW STRUCTURE** NEW BLOCKWORK

EXISTING STRUCTURE

EXISTING BLOCKWORK

HOLD - AREAS TBC / COORDINATED

GENERAL PROJECT CODES

AHD Australian Height Datum AP# Access Panel - Type #

ASSL Above Structural Slab Level AUTO Automatic Door BDY Boundary

BG# Box Gutter - Type # BIN# Bin - Type #

BMG# Boom Gate BO# Bollard - Type # BPR# Bump Rail - Type #

BAL# Balustrade - Type # BYR# Bicycle Rack - Type # C-FR Column fire rated to achieve 120/120/120

CG# Corner Guard - Type # CL# Cladding - Type #

CON# Concrete - Finish # CONP# Concrete Precast - Finish #

CPT# Carpet - Type # CS# Cubicle System - Type #

CT# Ceramic Tile - Type # CTS Centres (Setout)

D# Door - ID # DATAE Data Outlet - External DCM# Dirt Control Mat - Type #

DO# Drainage Outlet - Type # EXIT Exit Sign

FCL Finished Ceiling Level FE# Fire Extinguisher - Type #

FF Finished Face

FFL Finished Floor Level FH Fire Hydrant

FHR Fire Hose Reel FPL Finished Paving Level

FT# Façade - Type # FW# Floor Waste - Type #

GF# Grated Floor - Type #

GPO General Purpose Outlet HR# Handrail - Type # L# Lift - ID #

LC# Locker - Type # LF# Light Fitting - Type #

LV# Louvre - Type # P# Partition - Type # (Wall Code System only - e.

PC# Paint Colour RF# Resilient Floor Finish - Type #

ROF# Roofing - Type # RWO# Rain Water Outlet - Type #


SC# Column - ID # SE# Seat - Type #

SSL Structural Slab Level

ST# Stone - Type # STR# Stair - ID # TGI# Tactile Ground Indicator - Type #


VT# Vinyl Tile - Type # VU# Vanity Unit - Type # WPS# Waterproofing System - Type #



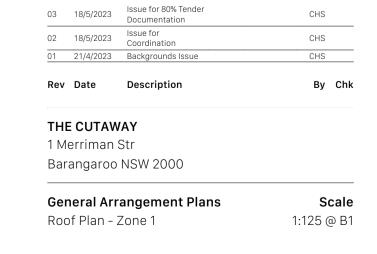

**Project Code** First Issued BCY 21/4/2023 Sheet No. Rev 20030


# North Street Level Temps

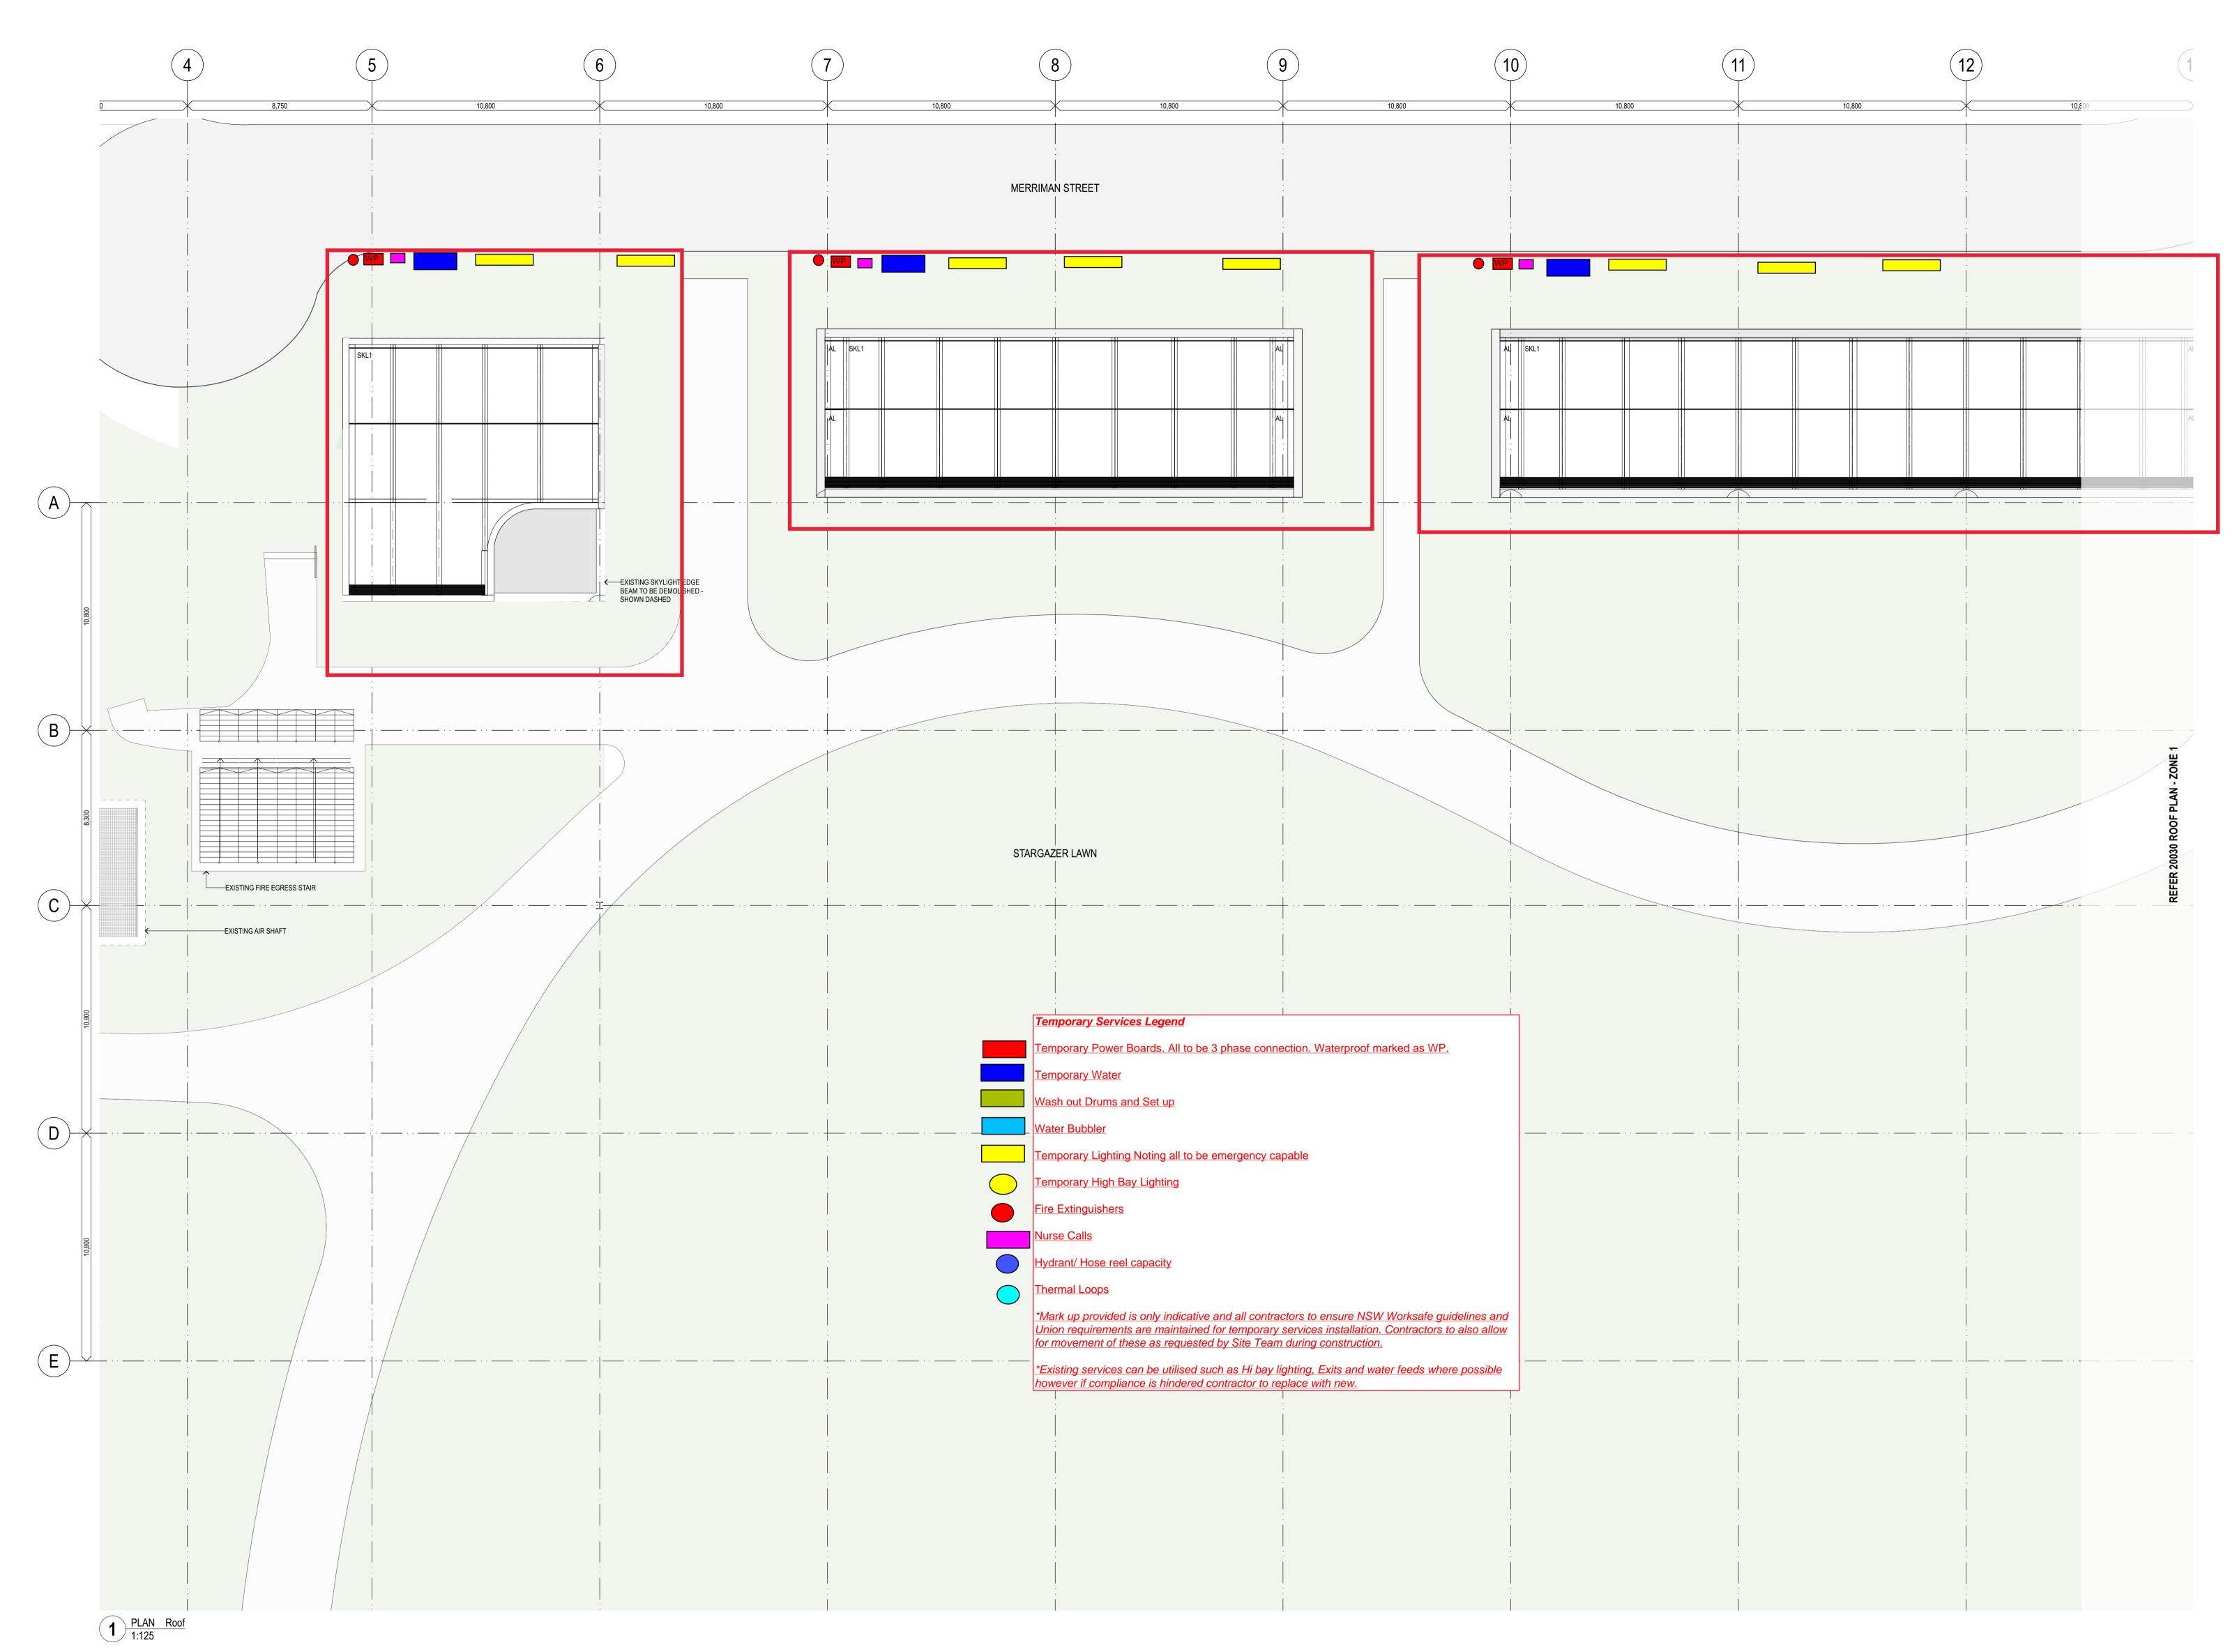



#### General notes

 All dimensions and existing conditions shall be checked and verified by the contractor before proceeding with the work. All levels relative to 'Australian Height Datum'. Do not scale drawings. Use figured dimensions only.

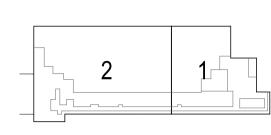

### DESIGN RESOLUTION

- The dimensions shown are general only and are subject to further design resolution. - Ceiling RL (where shown) indicates general ceiling design level only. - Location of plant, equipment and services on drawings is general and indicative, and does not include minor elements, such as vent

pipes, flues, aerial, etc. GRAPHIC PRESENTATION - Colours presented on drawings are generic only and indicative of the architectural design intent. Some colour distortion may also occur in the printing process. EXISTING STRUCTURES AND SERVICES

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### **NEW STRUCTURE** NEW BLOCKWORK







## GENERAL PROJECT CODES

COORDINATED

AHD Australian Height Datum AP# Access Panel - Type # ASSL Above Structural Slab Level

AUTO Automatic Door BDY Boundary

BG# Box Gutter - Type # BIN# Bin - Type #

BMG# Boom Gate BO# Bollard - Type # BPR# Bump Rail - Type #

BAL# Balustrade - Type # BYR# Bicycle Rack - Type # C-FR Column fire rated to achieve 120/120/120

CG# Corner Guard - Type # CL# Cladding - Type #

CON# Concrete - Finish # CONP# Concrete Precast - Finish #

CPT# Carpet - Type # CS# Cubicle System - Type #

CT# Ceramic Tile - Type # CTS Centres (Setout)

D# Door - ID # DATAE Data Outlet - External

DCM# Dirt Control Mat - Type # DO# Drainage Outlet - Type #

EXIT Exit Sign FCL Finished Ceiling Level

FE# Fire Extinguisher - Type # FF Finished Face

FFL Finished Floor Level FH Fire Hydrant

FHR Fire Hose Reel FPL Finished Paving Level

FT# Façade - Type #

FW# Floor Waste - Type # GF# Grated Floor - Type #

GPO General Purpose Outlet HR# Handrail - Type #

L# Lift - ID # LC# Locker - Type # LF# Light Fitting - Type #

LV# Louvre - Type # P# Partition - Type # (Wall Code System only - e.

PC# Paint Colour RF# Resilient Floor Finish - Type #


ROF# Roofing - Type #

RWO# Rain Water Outlet - Type # SC# Column - ID #

SE# Seat - Type # SSL Structural Slab Level

ST# Stone - Type # STR# Stair - ID #

TGI# Tactile Ground Indicator - Type # VT# Vinyl Tile - Type #

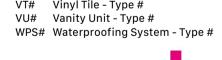




02	18/5/2023	Issue for Coordination Backgrounds Issue	CHS
Rev	Date	Description	Ву

Barangaroo NSW 2000

**General Arrangement Plans** Scale Roof Plan - Zone 2 1:125 @ B1

**Project Code** First Issued BCY 21/4/2023 Sheet No. Rev 20031

# Basement Floor Temps

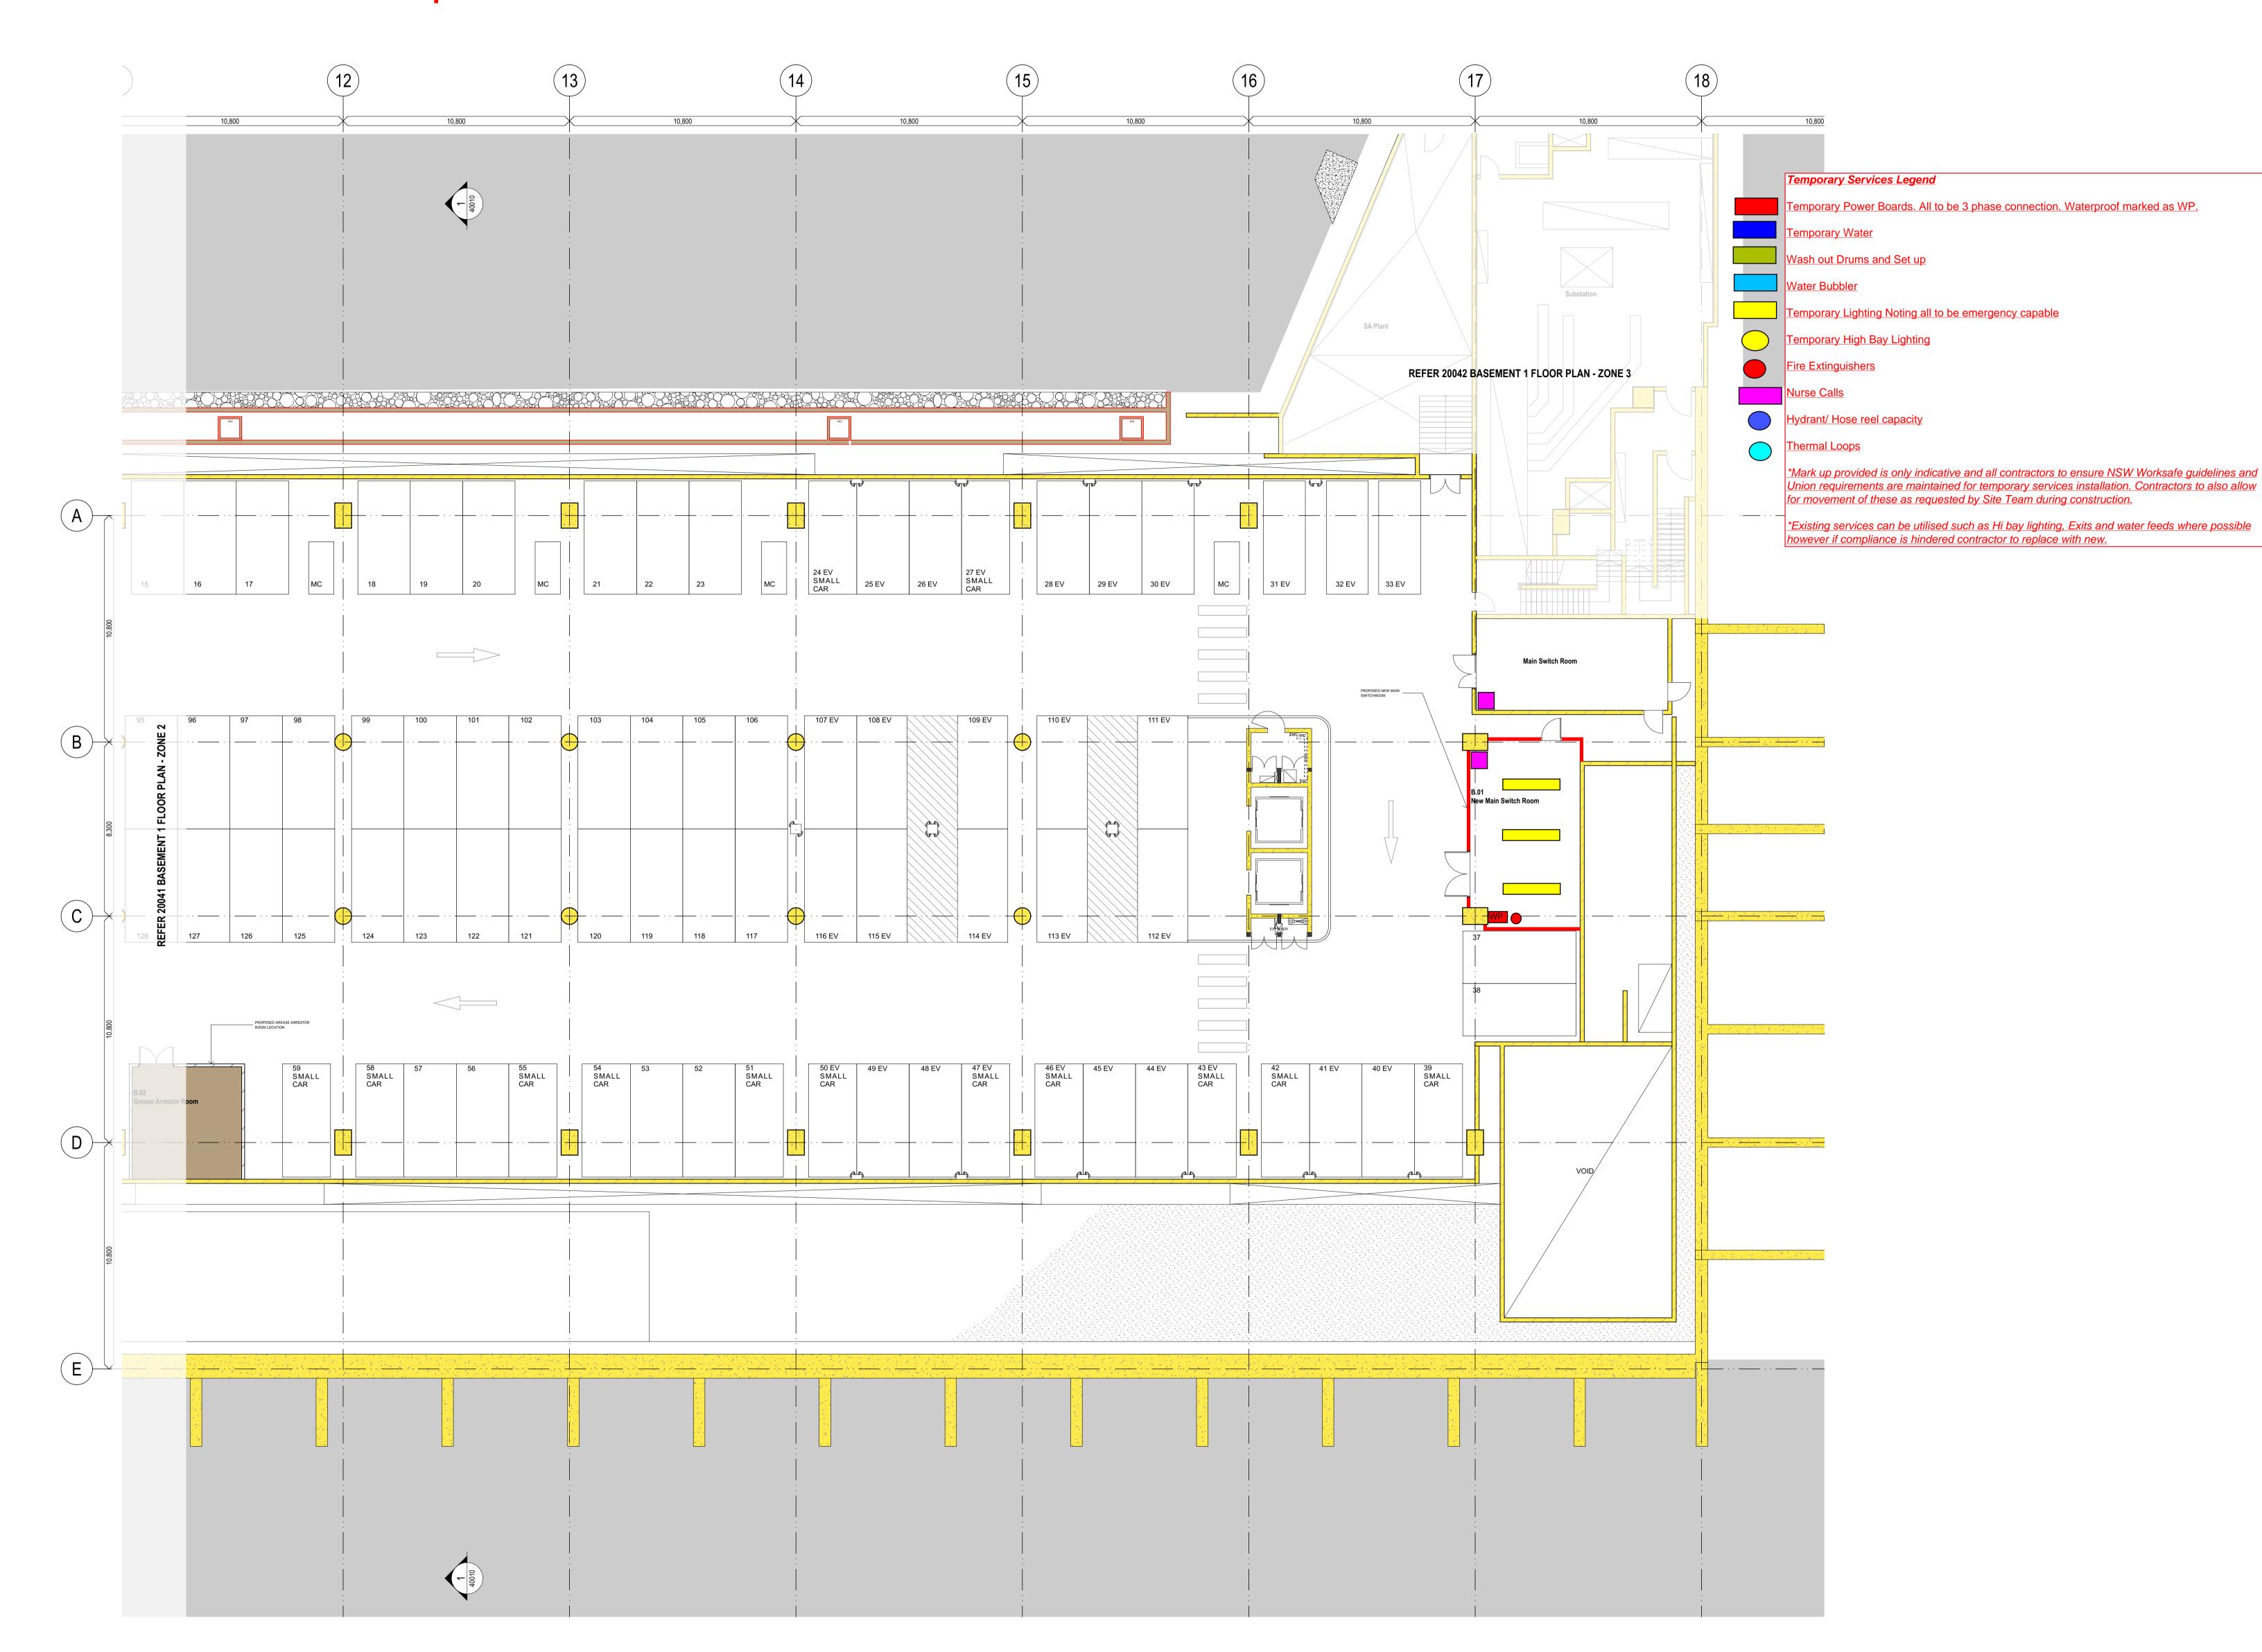




General notes All dimensions and existing conditions shall be

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 All levels relative to 'Australian Height Datum'. Do not scale drawings. Use figured dimensions only.

proceeding with the work.

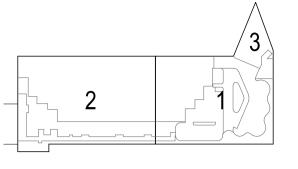

DESIGN RESOLUTION

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**NEW STRUCTURE** NEW BLOCKWORK

**EXISTING STRUCTURE** 

and will require further cordination.

EXISTING BLOCKWORK

HOLD - AREAS TBC /

COORDINATED

GENERAL PROJECT CODES

AHD Australian Height Datum AP# Access Panel - Type #

ASSL Above Structural Slab Level AUTO Automatic Door BDY Boundary

BG# Box Gutter - Type # BIN# Bin - Type # BMG# Boom Gate BO# Bollard - Type #

BPR# Bump Rail - Type # BAL# Balustrade - Type # BYR# Bicycle Rack - Type #

C-FR Column fire rated to achieve 120/120/120 CG# Corner Guard - Type #

CL# Cladding - Type # CON# Concrete - Finish # CONP# Concrete Precast - Finish #

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D# Door - ID # DATAE Data Outlet - External

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EXIT Exit Sign FCL Finished Ceiling Level

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FFL Finished Floor Level FH Fire Hydrant

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GPO General Purpose Outlet HR# Handrail - Type #

L# Lift - ID # LC# Locker - Type #

LF# Light Fitting - Type # LV# Louvre - Type #

P# Partition - Type # (Wall Code System only - e. PC# Paint Colour

RF# Resilient Floor Finish - Type # ROF# Roofing - Type #

RWO# Rain Water Outlet - Type #

SC# Column - ID # SE# Seat - Type #

SSL Structural Slab Level

ST# Stone - Type # STR# Stair - ID# TGI# Tactile Ground Indicator - Type #

VT# Vinyl Tile - Type # VU# Vanity Unit - Type # WPS# Waterproofing System - Type #




04	18/5/2023	Issue for 80% Tender Documentation	CHS	
03	18/5/2023	Issue for Coordination	CHS	
02	21/4/2023	Backgrounds Issue	CHS	
01	10/3/2023	Issue	CHS	
Rev	Date	Description	Ву	Chk
THE	CUTAW	/AY		
1 M	erriman	Str		
Bar	angaroo	NSW 2000		
Dui	angaroo	11011 2000		

**General Arrangement Plans** Scale Basement Plan - Zone 1 1:125 @ B1

First Issued **Project Code** BCY 10/3/2023 Sheet No. Rev 20040

# Basement Floor Temps

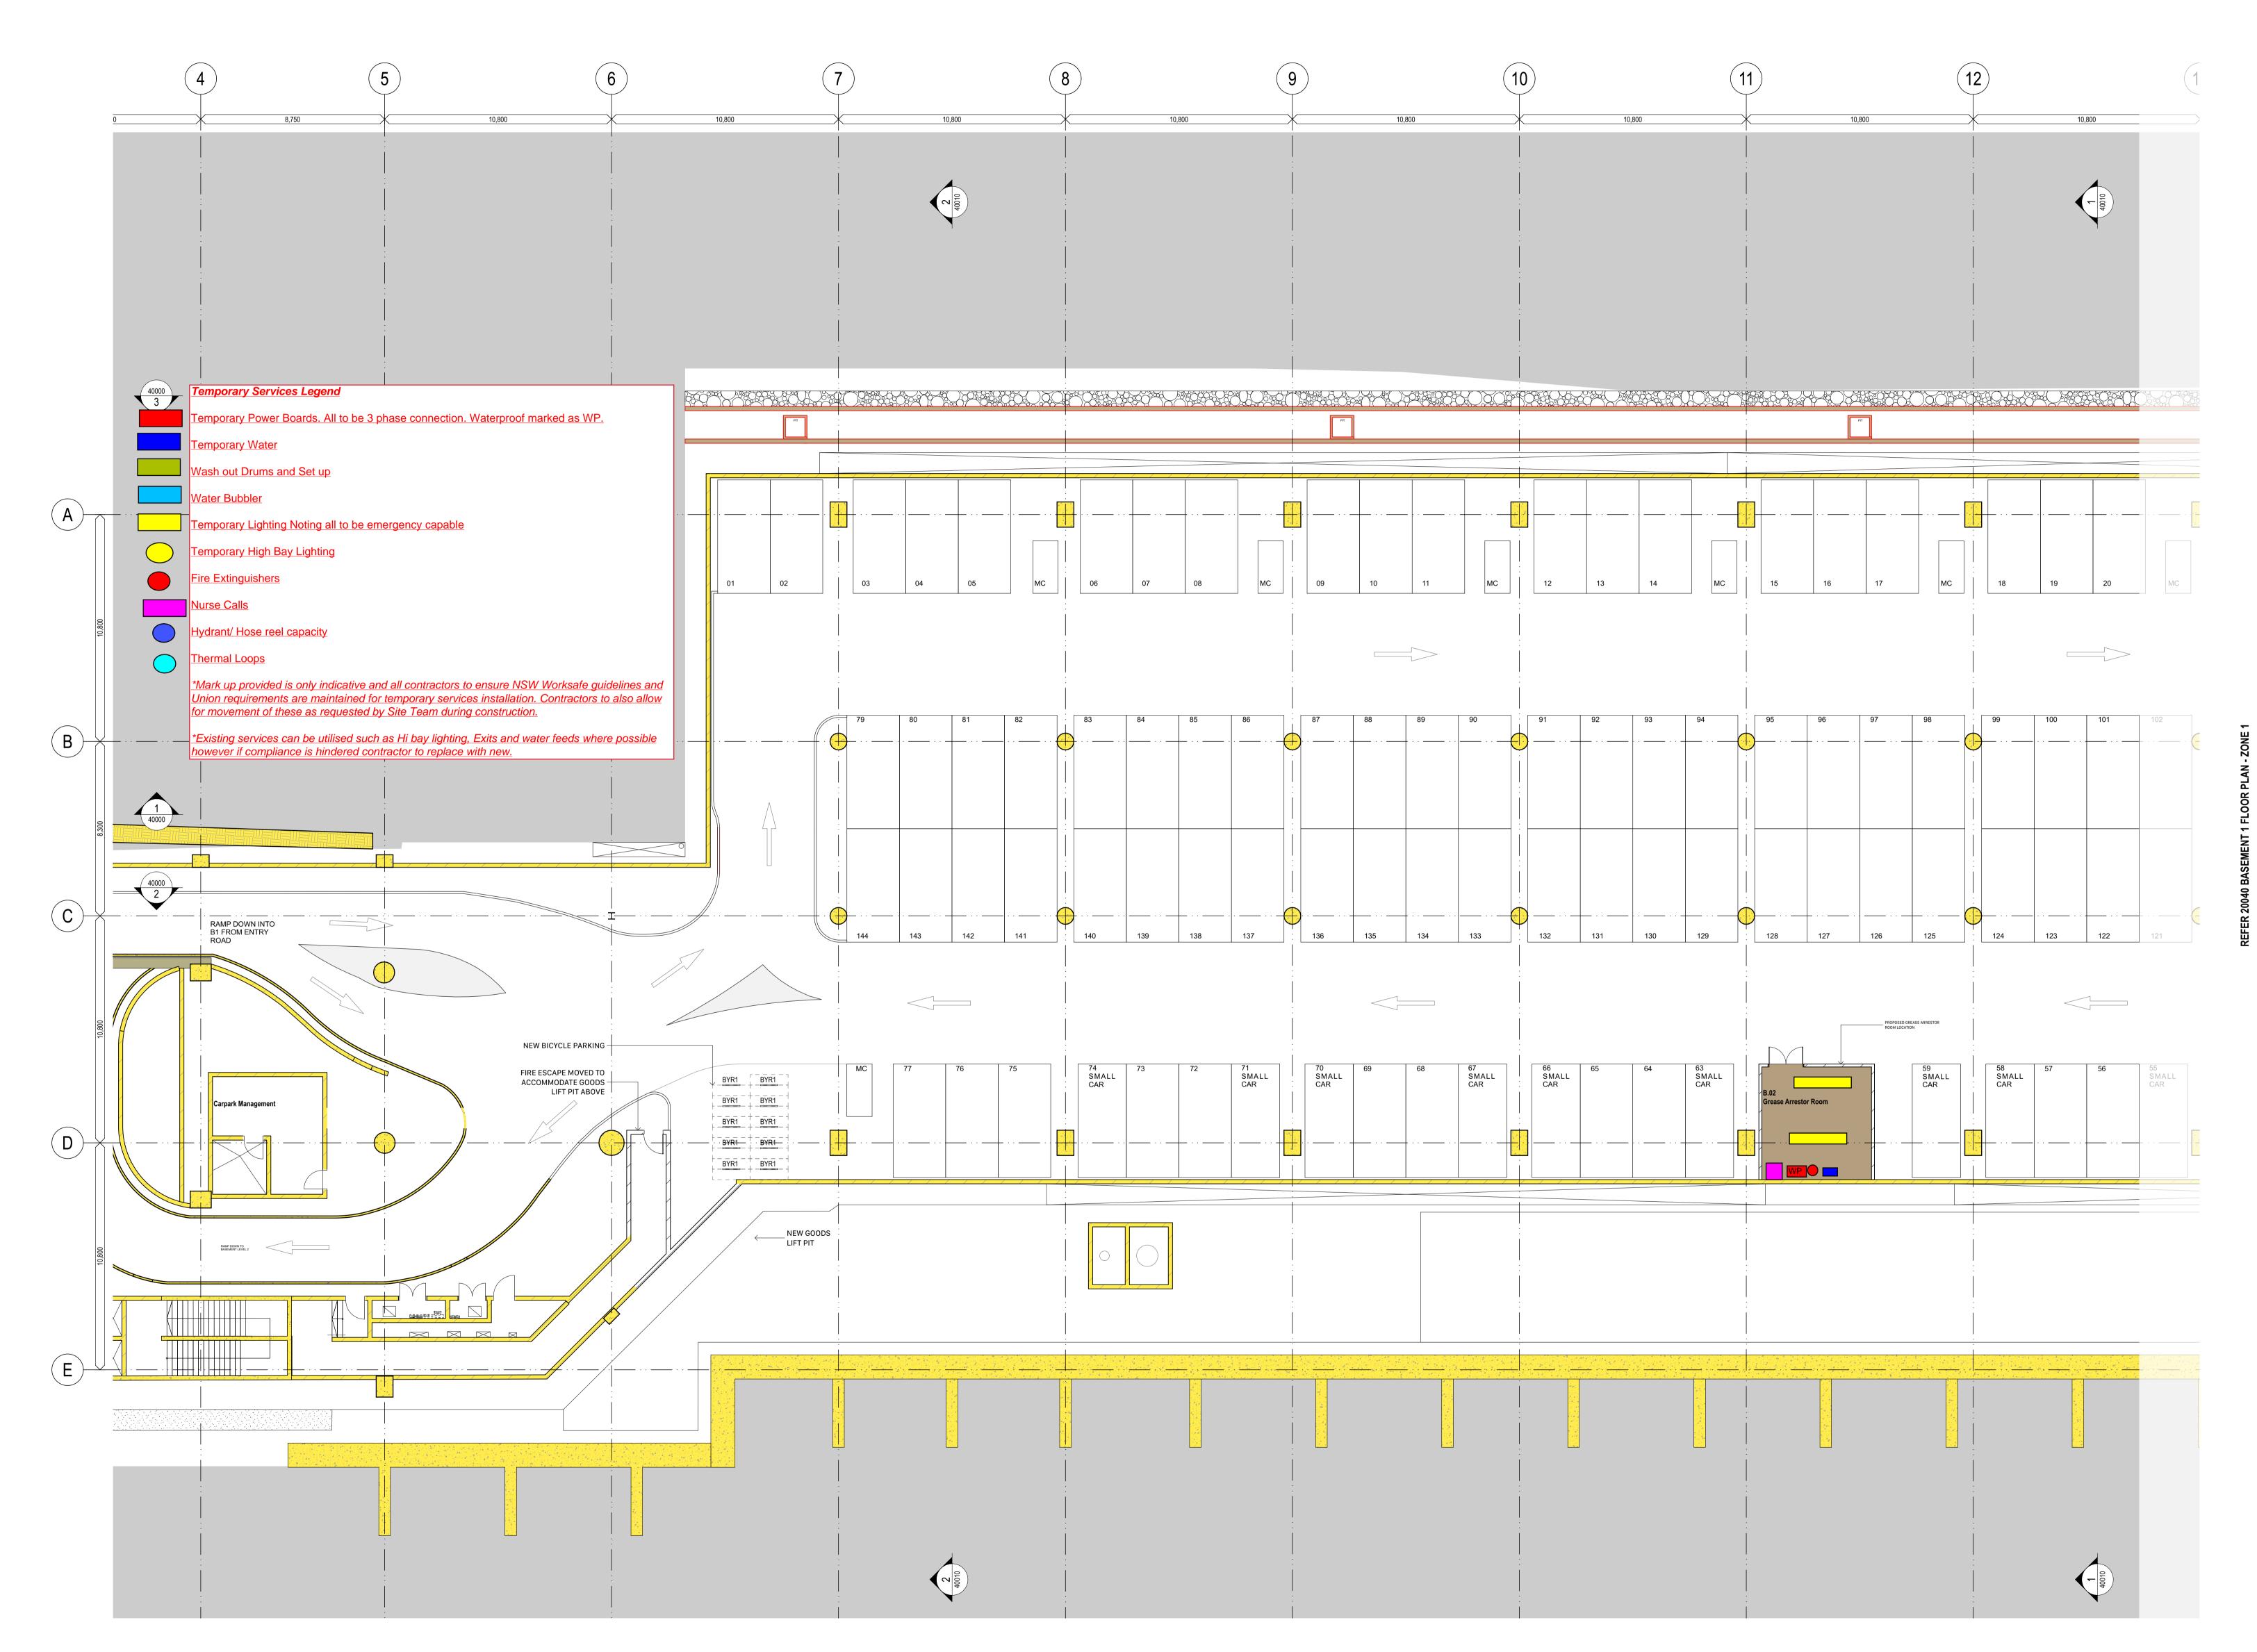




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General notes

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**NEW STRUCTURE** NEW BLOCKWORK

**EXISTING STRUCTURE** 

EXISTING BLOCKWORK

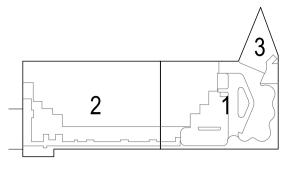HOLD - AREAS TBC / COORDINATED

GENERAL PROJECT CODES

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ASSL Above Structural Slab Level AUTO Automatic Door BDY Boundary

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CONP# Concrete Precast - Finish # CPT# Carpet - Type #

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CTS Centres (Setout)
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DCM# Dirt Control Mat - Type # DO# Drainage Outlet - Type #

EXIT Exit Sign

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FF Finished Face

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FH Fire Hydrant FHR Fire Hose Reel

FPL Finished Paving Level FT# Façade - Type #

FW# Floor Waste - Type # GF# Grated Floor - Type #

GPO General Purpose Outlet HR# Handrail - Type #

L# Lift - ID # LC# Locker - Type #

LF# Light Fitting - Type # LV# Louvre - Type #

P# Partition - Type # (Wall Code System only - e. PC# Paint Colour

RF# Resilient Floor Finish - Type #

ROF# Roofing - Type # RWO# Rain Water Outlet - Type #


SC# Column - ID # SE# Seat - Type #

SSL Structural Slab Level ST# Stone - Type #

STR# Stair - ID# TGI# Tactile Ground Indicator - Type #

VT# Vinyl Tile - Type # VU# Vanity Unit - Type # WPS# Waterproofing System - Type #



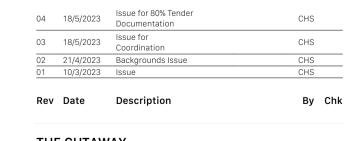

THE CUTAWAY 1 Merriman Str Barangaroo NSW 2000

**General Arrangement Plans** Basement Plan - Zone 2

First Issued **Project Code** BCY 10/3/2023 Sheet No. 20041

Scale


1:125 @ B1



Ph: 13001HOIST
www.aussiehoist.com.au
SYDNEY 12 Loftus St Arncliffe 2205
MELBOURNE 59 Tanbridge Way Warranwood 3134

### MABER MB3500



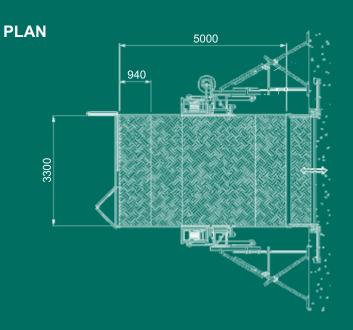



Maber Materials Hoists	Capacity (kg)	Platform Size (m)	Ramp Size (m)	Platform height to Ground (mm)	Power Outlet Required	Power Circuit Required	Min Generator	Ground Footprint Required (m)	Min Penetration Size (m)	Mast** Location	3rd ramp size (m)	Stowed Height	Min Door size*** (m)
MB2500	2400	2.1 x 4	2.1 x 1	450	50amp 5pin 415V	Min 16mm² cable 60A C/B	70KVA 415V	3.2* x 4.2	2.8* x 4.5	Both	n/a	2	3.2 x 2.2
MB3500	3500	3.3 x 5	3.2 x 1	800	50amp 5pin 415V	Min 16mm² cable 60A C/B	100KVA 415V	5.2* x 5.2	4.8* x 5.4	Both	n/a	2.2	5 x 2.4

Is distance along the edge of structure. This is the side where materials are offloaded from hoist to building. The other dimension is measured out or away from the building.

<sup>\*\*</sup> This is specified when standing outside of the building looking towards the building at the location of the hoist (when standing within the building it is opposite)
\*\*\* This is with machine either folded up, or separated to the smallest possible component for transport.



### 4.0 Appendix C – Hoarding Plans

: Address:	5 TOWNS PLACE, BARANGAROO NSW 2000					
: Title:	PROPOSED TEMPORARY WORKS					
g Title:	GENERAL NOTES	Drawing No: S101				
Date dd.mm.yy	Description	DP Full Name	Reg No			
10.04.24	ISSUED FOR CONSTRUCTION	DAVID ZAITER	DEP0000078			
19.04.24	ISSUED FOR CONSTRUCTION	DAVID ZAITER	DEP0000078			
	Title:  g Title:  Date dd.mm.yy  10.04.24	Title: PROPOSED TEMPORARY WORKS  g Title: GENERAL NOTES  Date dd.mm.yy Description  10.04.24 ISSUED FOR CONSTRUCTION	Title: PROPOSED TEMPORARY WORKS  g Title: GENERAL NOTES Drawing No:  Date dd.mm.yy Description DP Full Name  10.04.24 ISSUED FOR CONSTRUCTION DAVID ZAITER			

ARCHITECT:

CLIENT:

BUILDER:

5 TOWNS PLACE,

Engineering Solutions Pty Ltd

DRAWING TITLE:

DRAWING

STATUS:

JOB No.

DESIGNED: YM

DRAWN: EE

CHECKED: DZ

24-3924

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**GENERAL NOTES** 

BARANGAROO NSW 2000

PROPOSED TEMPORARY WORKS

Suite 5, 5-7 Villiers Street, Parramatta, NSW 2150

Phone: 02 9630 3087 Email: info@zait.com.au

ABN 40 608 862 899

ACN 608 862 899

ISSUED FOR CONSTRUCTION

REV.

DAVID ZAITER

BEng(Hons). MIEAust. CPEng NER RPEQ

As indicated A1

DRAWING No.

S101

# PROPOSED TEMPORARY WORKS 5 TOWNS PLACE, BARANGAROO NSW 2000

#### **GENERAL**

- G1 STRUCTURAL DRAWINGS SHALL BE READ IN CONJUNCTION WITH THE SPECIFICATION, ARCHITECTURAL, CIVIL & RELEVANT ENGINEERING SERVICES DOCUMENTS AND WITH OTHER SUCH WRITTEN INSTRUCTIONS AS MAY BE ISSUED.
- G2 ALL DIMENSIONS SHOWN SHALL BE VERIFIED ON SITE. ENGINEERS DRAWINGS MUST NOT BE SCALED.
- G3 DURING CONSTRUCTION THE STRUCTURE SHALL BE MAINTAINED IN A STABLE CONDITION & NO PART SHALL BE OVERSTRESSED.
- G4 ALL MATERIALS & WORKMANSHIP SHALL BE IN ACCORDANCE WITH THE SPECIFICATION.
- G5 UNLESS OTHERWISE NOTED ALL LEVELS ARE IN METRES & ALL DIMENSIONS ARE IN MILLIMETRES.
- G6 U.N.O. DENOTES UNLESS NOTED OTHERWISE.
- G7 TERMITE PROTECTION TO AS3660.1

### **FOUNDATIONS**

F1. THIS SITE HAS BEEN ASSUMED TO HAVE AN ALLOWABLE BEARING INTENSITY OF 100 kPa. TO BE CONFIRMED BY A GEOTECHNICAL ENGINEER

### SAFETY IN DESIGN (SID)

- SD1. A SAFETY IN DESIGN RISK ASSESSMENT HAS BEEN COMPLETED FOR THE WORKS AND ALL REASONABLE STEPS HAVE BEEN TAKEN TO ENSURE HAZARDS AND RISKS NORMALLY ASSOCIATED WITH THIS TYPE OF DESIGN HAVE BEEN MITIGATED AND/OR COMMUNICATED.
- SD2. RESIDUAL HAZARDS AND RISKS AND/OR HAZARDS AND RISKS NOT NORMALLY ASSOCIATED WITH THIS TYPE OF WORK WHICH MAY REQUIRE SUBSEQUENT CONSIDERATION AND/OR ACTION ARE NOTED BELOW.

### CONSTRUCTION

C1. EXISTING SERVICES

CONTRACTOR TO BE AWARE EXISTING SERVICES ARE LOCATED WITHIN THE SITE. LOCATION OF ALL SERVICES TO BE VERIFIED BY THE CONTRACTOR PRIOR TO COMMENCING WORKS. CONTRACTOR TO CONFIRM WITH RELEVANT AUTHORITY REGARDING MEASURES TO BE TAKEN TO

C2. LOCATIONS THAT HAVE RESIDUAL RISK ARE INDICATED ON THE PLANS BY THIS SYMBOL:

### MAINTENANCE/CLEANING OPERATIONS

M1. ALL ROOF MEMBERS ARE TO BE SUBJECT TO WIND LOADING ONLY- NO FOOT TRAFFIC IS PERMITTED ON ROOFS.

### DECOMMISSIONING/DEMOLITION

- DD1. NO RESIDUAL HAZARDS OR RISKS ARE NOTED FOR MAINTENANCE.
- DD2. IT IS THE CLIENT'S RESPONSIBILITY TO PROVIDE A COPY OF THE STRUCTURAL RISK AND SOLUTIONS REGISTER TO THE PRINCIPAL CONTRACTOR.
- DD3. THE PRINCIPAL CONTRACTOR SHALL UNDERTAKE THEIR OWN ASSESSMENT OF HAZARDS AND ASSOCIATED RISK. THE CONTRACTOR IS REQUIRED TO UNDERTAKE THE WORK IN A SAFE MANNER IN ACCORDANCE WITH RELEVANT GUIDELINES AND LEGISLATION.

#### STRUCTURAL STEELWORK NOTES

- ALL MATERIALS, WORKMANSHIP, FABRICATION AND ERECTION SHALL COMPLY WITH THE REQUIREMENTS OF AS4100, AS1538, AS1554 AND THE
- S2 UNLESS SHOWN OTHERWISE, ALL STEEL SHALL BE IN ACCORDANCE WITH AS1204 GRADE 300. ALL STEEL HOLLOW SECTIONS SHALL BE GRADE 350 U.N.O. AND SHALL BE IN ACCORDANCE WITH AS1163. ALL PRESSED METAL PURLINS AND GIRTS SHALL BE GRADE 450 STEEL IN ACCORDANCE WITH
- S3 UNLESS SHOWN OTHERWISE ON THE DRAWINGS, ALL CONNECTIONS SHALL BE IN ACCORDANCE WITH THE FOLLOWING MINIMUM REQUIREMENTS: ALL WELDS SHALL BE 6MM CONTINUOUS FILLET WELDS ALL AROUND.
  - ALL BOLTS SHALL BE M20 8.8/S, WITH A MINIMUM OF 2 BOLTS PER CONNECTION. PURLIN BOLTS TO BE M12 4.6/S WITH A MINIMUM OF 2 BOLTS PER PURLIN END.
  - (iii) ALL GUSSET AND CLEAT PLATES SHALL BE 10mm THICK. (U.N.O.)
  - ALL CAP PLATES SHALL BE 10 mm THICK. (U.N.O.)
- (v) ALL BASE PLATES SHALL BE 10 mm THICK. (U.N.O.)

4.6/S REFERS TO COMMERCIAL BOLTS OF STRENGTH GRADE 4.6 TO AS1111 TIGHTENED TO A SNUG TIGHT CONDITION.

8.8/S REFERS TO HIGH STRENGTH STRUCTURAL BOLTS OF GRADE 8.8 TO AS1252 TIGHTENED TO A SNUG TIGHT CONDITION.

8.8/TB REFERS TO HIGH STRENGTH STRUCTURAL BOLTS OF GRADE 8.8 TO AS1252 FULLY TENSIONED TO AS4100 AS A BEARING JOINT.

- 8.8/TF REFERS TO HIGH STRENGTH STRUCTURAL BOLTS OF GRADE 8.8 TO AS1252 FULLY TENSIONED TO AS4100 AS A FRICTION JOINT
- S5 HIGH STRENGTH BOLTED JOINTS SHALL BE IN ACCORDANCE WITH AS1511. THE SPECIFIED BOLT TENSION SHALL BE OBTAINED BY USE OF THE
- "PART TURN" METHOD OF TIGHTENING.
- S6 ALL WELDS SHALL BE SP (SPECIAL PURPOSE) IN ACCORDANCE WITH AS1554. ALL ELECTRODES SHALL BE CLASS E48. ALL BUTT WELDS SHALL BE FULL STRENGTH COMPLETE PENETRATION WELDS.
- S7 SUBSTITUTIONS FOR STEEL SECTIONS SHOWN ON DRAWINGS SHALL NOT BE MADE WITHOUT THE APPROVAL OF THE ENGINEER.
- S8 ALL STEELWORK BELOW GROUND OR FINISHED SURFACE LEVEL IS TO BE ENCASED IN 75mm MIN. CONCRETE ALL ROUND.
- S9 ALL STEELWORK, EXCEPT THAT WHICH IS TO BE CONCRETE ENCASED, FIRE SPRAYED OR CONTACT SURFACES OF FRICTION TYPE JOINTS, SHALL BE SURFACE CLEANED AND PAINTED IN ACCORDANCE WITH THE SPECIFICATION.
- S10 STEELWORK THAT IS CONCRETE ENCASED, FIRE SPRAYED OR FACING SURFACES OF FRICTION TYPE JOINTS SHALL BE LEFT UNPAINTED AND FREE FROM SCALE.
- S11 THE CONTRACTOR SHALL PROVIDE ALL CLEATS AND DRILL ALL HOLES NECESSARY FOR FIXING STEEL, TIMBER AND OTHER ELEMENTS TO STEEL WHETHER OR NOT DETAILED ON THE DRAWINGS.
- THE FABRICATION AND ERECTION OF THE STRUCTURAL STEELWORK SHALL BE SUPERVISED BY QUALIFIED PERSONNEL EXPERIENCED IN SUCH SUPERVISION TO ENSURE THAT ALL REQUIREMENTS OF THE DESIGN ARE MET. DETAILS OF ERECTION SEQUENCE SHALL BE SUBMITTED TO THE ENGINEER FOR APPROVAL PRIOR TO COMMENCEMENT OF ERECTION.
- S13 COLUMNS AND MULLIONS SHALL HAVE THEIR BASE PLATES FULLY GROUTED IN ACCORDANCE WITH THE SPECIFICATIONS AFTER PLUMBING AND
- S14 UNLESS SPECIFIED OTHERWISE, STEELWORK SHALL BE PREPARED TO CLASS 2.5 FINISH IN ACCORDANCE WITH AS1627.4 AND GIVEN TWO (2 ) COATS OF ZINC PHOSPHATE TO A TOTAL DRY FILM THICKNESS OF 70 MICRONS.

### TIMBER NOTES

- T1. ALL TIMBER DESIGN AND CONSTRUCTION TO BE TO AS 1720 U.N.O.
- T2. AS 1684 IS RELEVANT TO DOMESTIC CONSTRUCTION IN SHELTERED LOCATIONS.
- T3. SOFTWOOD MINIMUM GRADE F7 U.N.O. HARDWOOD MINIMUM GRADE F14 U.N.O.
- T4. EXTERNAL TIMBER TO BE EITHER HARDWOOD DURABILITY CLASS I OR II OR IMPREGNATED GRADE F7. PRESSURE TREATED TO AS1684 AND RE-DRILLED PRIOR TO USE. SUPPLEMENTARY TREATMENT SHALL BE APPLIED TO ALL CUT SURFACES. PROVIDE DOCUMENTATION.
- T5. ALL BOLTS IN TIMBER CONSTRUCTION TO BE MIN. M16 U.N.O. BOLT HOLES TO BE DRILLED EXACT SIZE. WASHERS UNDER HEADS AND NUTS TO BE AT LEAST 2.5 TIMES BOLT DIAMETER.
- T6 FINISHED TIMBER SIZES

SEASONED SOFTWOOD F7+3,-3mm UNSEASONED SOFTWOOD F7+2,-4mm SEASONED HARDWOOD (SEE ALSO CLAUSE 1.6.2 IN AS 2082)

- T7. ALL TIMBER JOINTS AND NOTCHES TO BE 100mm MINIMUM FROM LOOSE KNOTS. SEVERE SLOPING GRAIN, GUM VEINS OR OTHER MINOR DEFECTS.
- BLOCKING IS NOT REQUIRED FOR JOISTS SPANNING LESS THAN 3m. FOR JOISTS SPANNING GREATER THAN 3m AND LESS THAN 4.2m PROVIDE ONE ROW OF BLOCKING MID-SPAN. FOR JOISTS SPANNING GREATER THAN 4.2m AND UP TO 6.0m PROVIDE TWO ROWS OF BLOCKING AT  $\frac{1}{3}$  POINTS. FOR DEEP JOIST FLOORS WHERE A CONTINUOUS TRIMMING JOIST IS NOT PROVIDED AT END OF JOISTS. BLOCKING IS REQUIRED AT 1800 MAXIMUM CENTRES. (REFER TO AS 1684)

#### WIND DESIGN PARAMETERS

STRUCTURAL IMPORTANCE LEVEL = 2

REGION = A2

ARI = 1:100

 $V_{100} = 41 \text{m/s}$ 

TERRAIN CATEGORY = 1.7

SITE WIND SPEED (ULTIMATE) = 38.4 m/s

DESIGN LIFE = TEMPORARY STRUCTURES <5 YEARS

#### **DESIGN LOADS**

#### AWNING LOADS

1.2m WIDE AWNING LOADS (NON-TRAFFICABLE ROOF)

DL = 0.1 kPa

WL (ULTIMATE) = 1.0 kPa (UPLIFT) WL (ULTIMATE) = 0.36 kPa (DOWN)

Project Address: 5 TOWNS PLACE, BARANGAROO NSW 2000 Project Title: PROPOSED TEMPORARY WORKS  Drawing Title: GROUND LEVEL HOARDING PLAN - PART 1  Rev Date dd.mm.yy Description DP Full Name Reg No 01 10.04.24 ISSUED FOR CONSTRUCTION DAVID ZAITER DEP0000078		
PROPOSED TEMPORARY WORKS 5 TOWNS PLACE, BARANGAROO NSW 2000  ARCHITECT:		90x45 MGP10 H3 TREATED HORIZONTAL RAILS  PLYWOOD  REFER TO HOARDING DETAIL  90x90 MGP10 H3 TREATED
CLIENT:  GS BUILDING  BUILDING  BUILDING		MIN. 200 THICK R.C. WALL (NON-CRACKED 40MPa) TBC BY BUILDER
Suite 5, 5-7 Villiers Street, Parramatta, NSW 2150 Phone: 02 9630 3087 Email: info@zait.com.au ABN 40 608 862 899 ACN 608 862 899 ACN 608 862 899 ACN 608 862 899  Engineering Solutions Pty Ltd  THE DRAWINGS, PLANS, SPECIFICATIONS AND THE COPYRIGHT ARE THE PROPERTY OF ZAIT ENGINEERING SOLUTIONS PTY LTD AND MUST NOT BE USED, REPRODUCED OR COPIED WHOLLY OR IN PART WITHOUT THE WRITTEN PERMISSION OF ZAIT ENGINEERING SOLUTIONS.  COPYRIGHT @ ALL RIGHTS RESERVED  DRAWING TITLE:  GROUND LEVEL HOARDING PLAN - PART 1  DRAWING STATUS:  ISSUED FOR CONSTRUCTION	GROUND LEVEL HOARDING PLAN - PART 1 SCALE 1:100	2M12 ANKASCREW XTREM 70mm MIN. EMBEDMENT INTO CONCRETE WALL
DESIGNED: YM  DAVID ZAITER BEND(Hons). MIEAust. CPEND NER RPEQ  DRAWN: EE  SCALE SIZE  CHECKED: DZ  As indicated A1  JOB No.  DRAWING No.  REV.  24-3924  S301  O1	NOTE:  1. DENOTES LOCATION OF TEMPORARY HOARDING FIXED TO CONCRETE WALL (REFER TO TYPICAL DETAILS).  2. DENOTES LOCATION OF STEEL GATE (REFER TO TYPICAL DETAIL).	EXISTING SLAB BY OTHERS T.B.C.  HOARDING FIXED TO CONCRETE WALL DETAIL SCALE 1:10

Project Address: 5 TOWNS PLACE, BARANGAROO NSW 2000	
Project Title: PROPOSED TEMPORARY WORKS	
Drawing Title: DOUBLE SWING GATE DETAILS Drawing No: S302	
Rev     Date dd.mm.yy     Description     DP Full Name     Reg No	
01 10.04.24 ISSUED FOR CONSTRUCTION DAVID ZAITER DEP0000078	EXISTING CONCRETE COLUMN
	TBC BY BUILDER  END PLATE
	REFER TO DETAIL  REFER TO DETAIL  FRAME 50 x 50 x 3.0 SHS
	(C350LU) GALVANISED
	6mm CFW/490/SP
	6mm CFW/490/SP TYPICAL
	17mm NON-STRUCTURAL
	SP1 - 89x89x4.0 SHS (C350L0) GALVANISED
	PROPRIETARY LATCH BY OTHERS  REFER TO DETAIL
PROJECT TITLE:	
PROPOSED TEMPORARY WORKS	END PLATE REFER TO DETAIL
5 TOWNS PLACE, BARANGAROO NSW 2000	
ARCHITECT:	BASE PLATE REFER TO DETAIL
	REFER TO DETAIL
	20mm MAX. NON-SHRINK GROUT
CLIENT:	
	EXISTING SLAB
GOVI	BY OTHERS T.B.C.
BUILDING	
BUILDER:	DOUBLE SWINGING GATE FIXED TO CONCRETE COLUMN DETAIL
GS /	SCALE 1:10  NOTE: GATE HEIGHT 2400mm. APPROX. 5000mm OPENING
BUILDING	APPROX. 5000mm OPENING
BUILDING	
Suite 5, 5-7 Villiers Street, Parramatta, NSW 2150 Pharm 03 0630 3007	16mm GALVANISED PLATE 2M16 8.8 GRADE THREADED RODS  RAMSET CHEMSET BEG 503 PLUS
Phone: 02 9630 3087 Email: info@zait.com.au ABN 40 608 862 899	RAMSET CHEMSET REO 502 PLUS  200 MIN. EMBEDMENT
Engineering Solutions Pty Ltd	6mm CFW/490/SP
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DRAWING TITLE:	16mm GALVANISED PLATE 4M16 8.8 GRADE THREADED RODS RAMSET CHEMSET REO 502 PLUS 150 MIN. EMBEDMENT  16mm GALVANISED PLATE 6mm CFW/490/SP BOTH SIDES
DOUBLE SWING GATE DETAILS	
DRAWING STATUS: ISSUED FOR CONSTRUCTION	END PLATE DETAIL (SP1)
	BASE PLATE DETAIL(SP1)
DESIGNED: YM DAVID ZAITER  BEng(Hons). MIEAust. CPEng NER RPEQ  DRAWN: EE SCALE SIZE	SCALE 1:10

DRAWN: EE CHECKED: DZ

24-3924

JOB No.

As indicated A1

DRAWING No.

S302

REV.

01

Project	: Address:	5 TOWNS PLACE, BARANGAROO	NSW 2000				
Project Title:		PROPOSED TEMPORARY WORKS					
Drawin	g Title:	GROUND LEVEL HOARDING PLAN - PART 2	Drawing No: \$303				
Rev	Date dd.mm.yy	Description	DP Full Name	Reg No			
01	19.04.24	ISSUED FOR CONSTRUCTION	DAVID ZAITER	DEP0000078			
02	19.04.24	ISSUED FOR CONSTRUCTION	DAVID ZAITER	DEP0000078			
03	17.01.25	ISSUED FOR CONSTRUCTION	DAVID ZAITER	DEP0000078			

PROPOSED TEMPORARY WORKS 5 TOWNS PLACE, BARANGAROO NSW 2000

ARCHITECT:

CLIENT:



BUILDER:





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DRAWING TITLE:

DRAWING


GROUND LEVEL HOARDING PLAN - PART 2

STATUS:		1330
DESIGNED:	ΥM	BEng(Hon
DRAWN:	EE	BENG(HON
CHECKED:	DZ	As
JOB No.		
24-39		

ISSUED FOR CONSTRUCTION

DAVID ZAITER Hons). MIEAust. CPEng NER RPEQ s indicated A1

REV. DRAWING No. S303 03

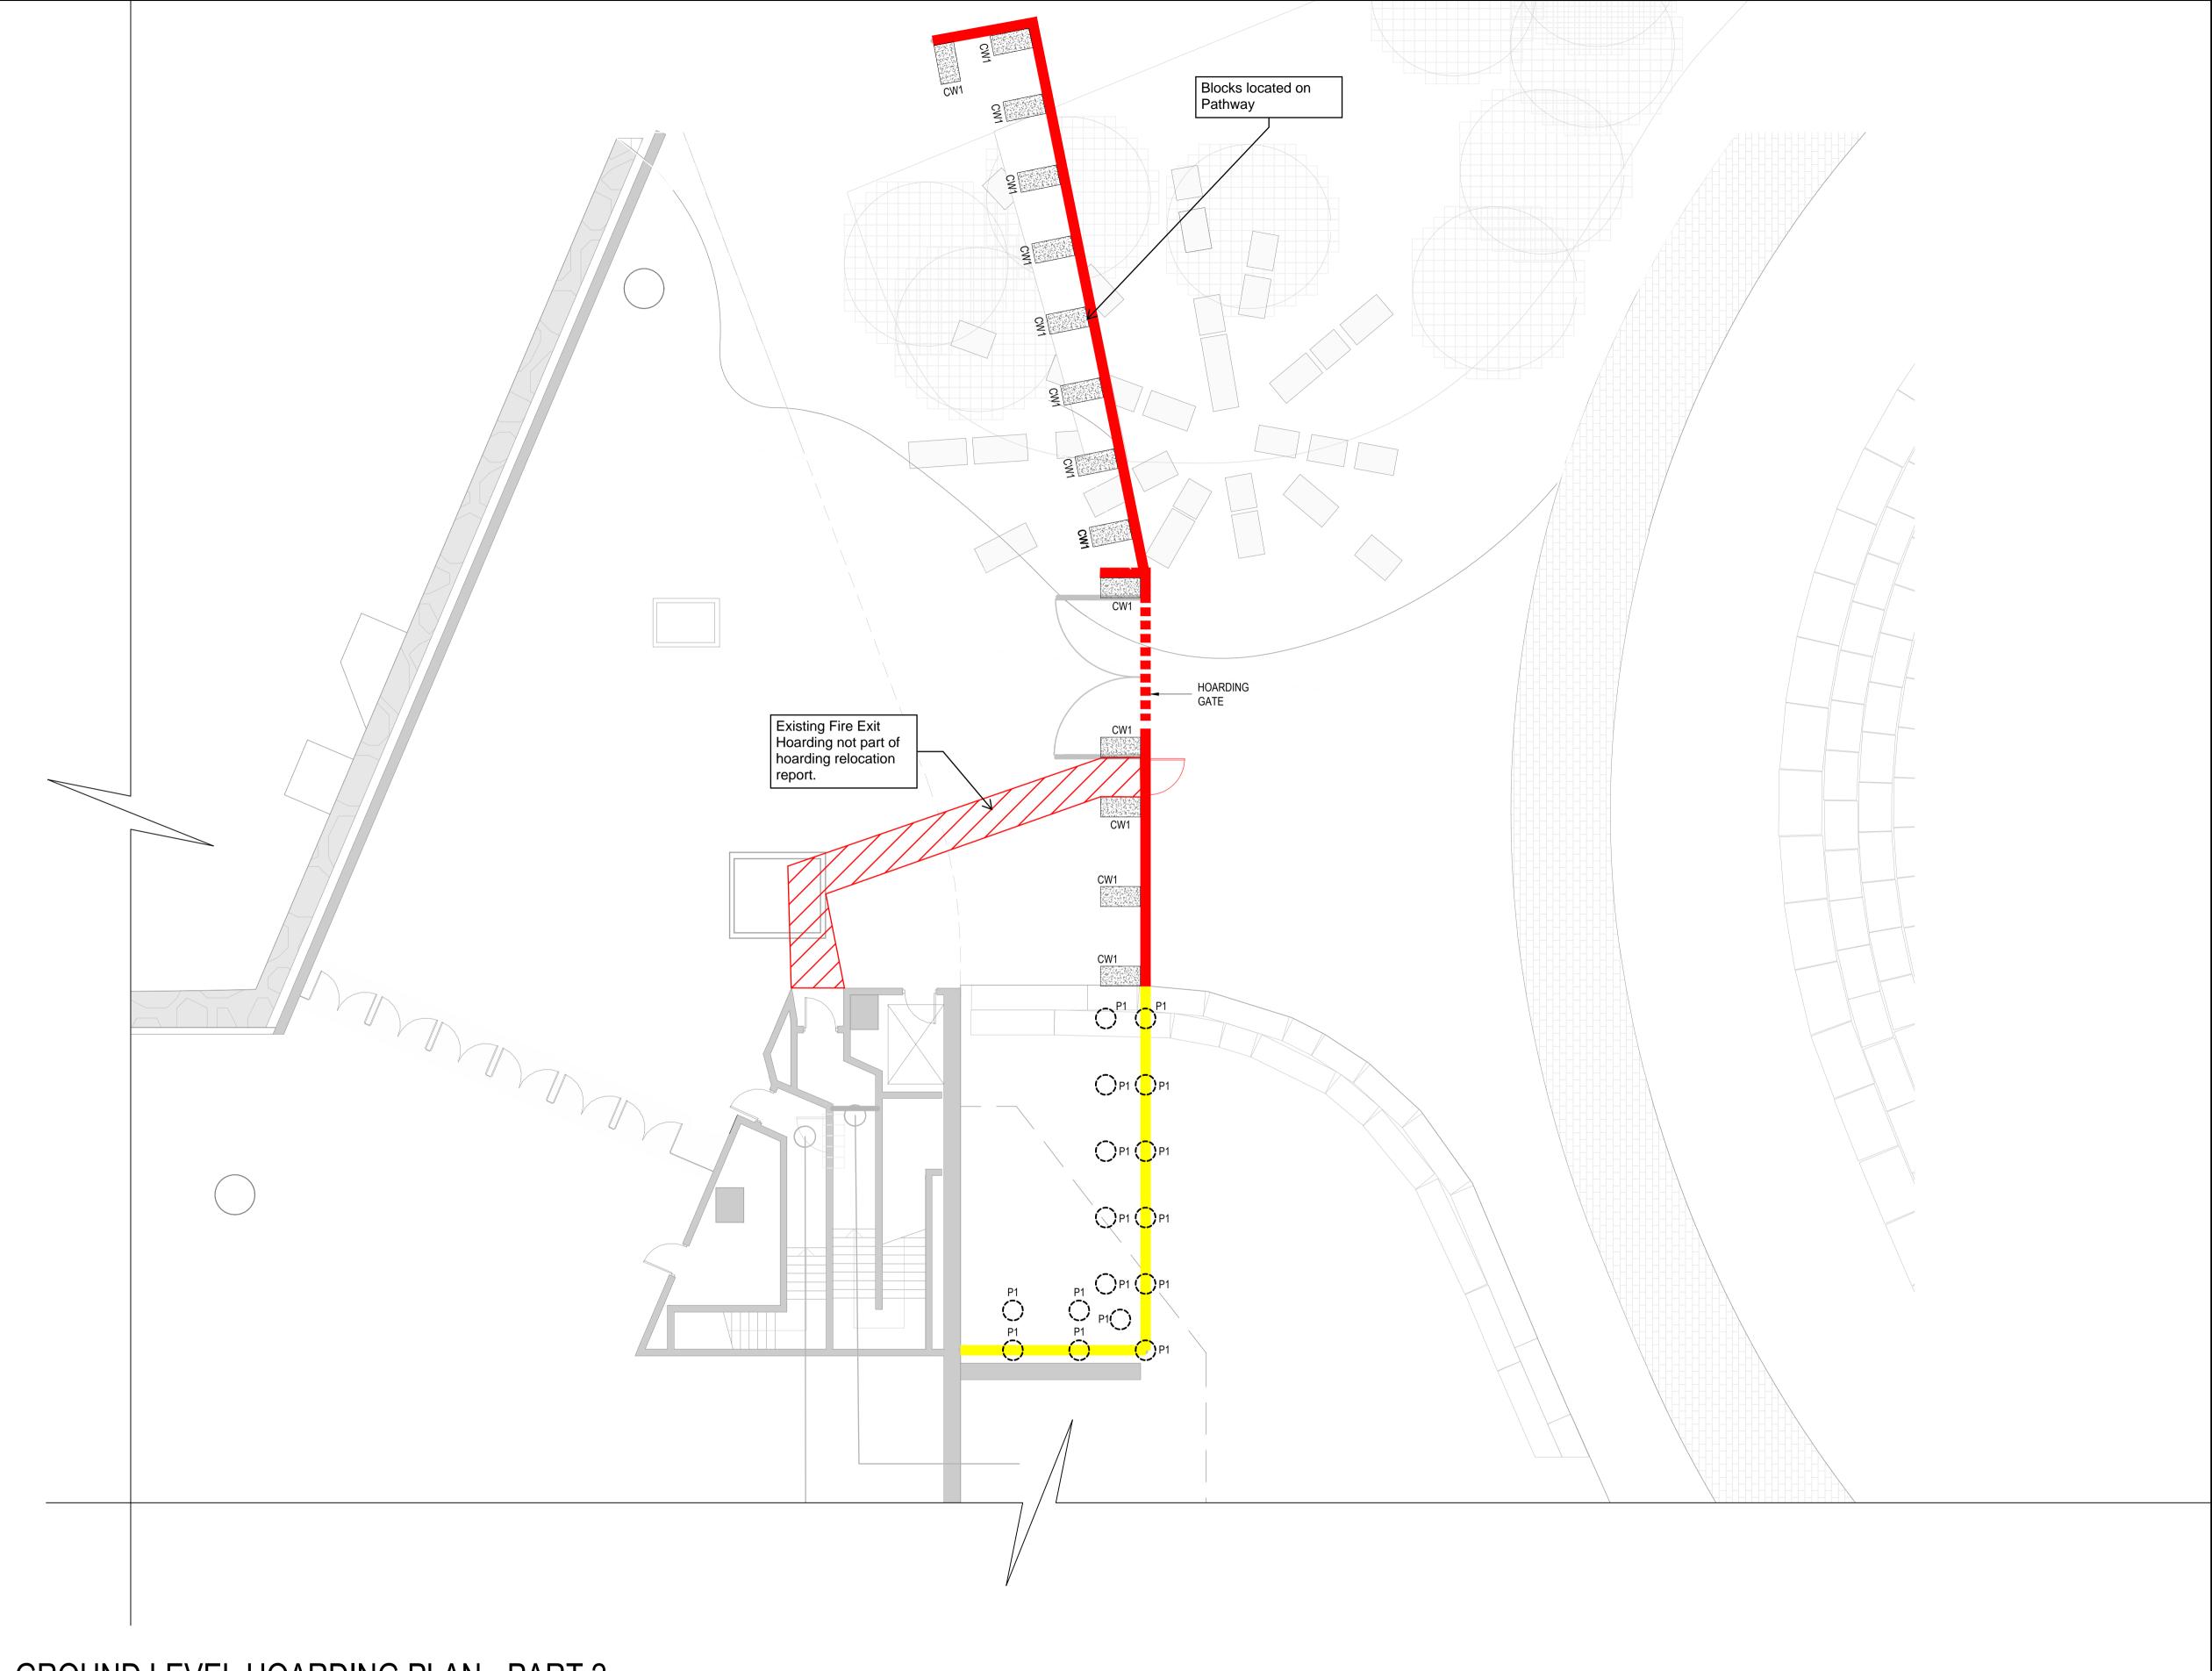


## GROUND LEVEL HOARDING PLAN - PART 2

SCALE 1:100

1. DENOTES LOCATION OF TEMPORARY HOARDING (REFER TO TYPICAL DETAILS). 2. DENOTES LOCATION OF TEMPORARY POST-IN-GROUND HOARDING (REFER TO TYPICAL DETAILS)

3. CW1 DENOTES 1200X600X600 1 TONNE CONCRETE BLOCK.

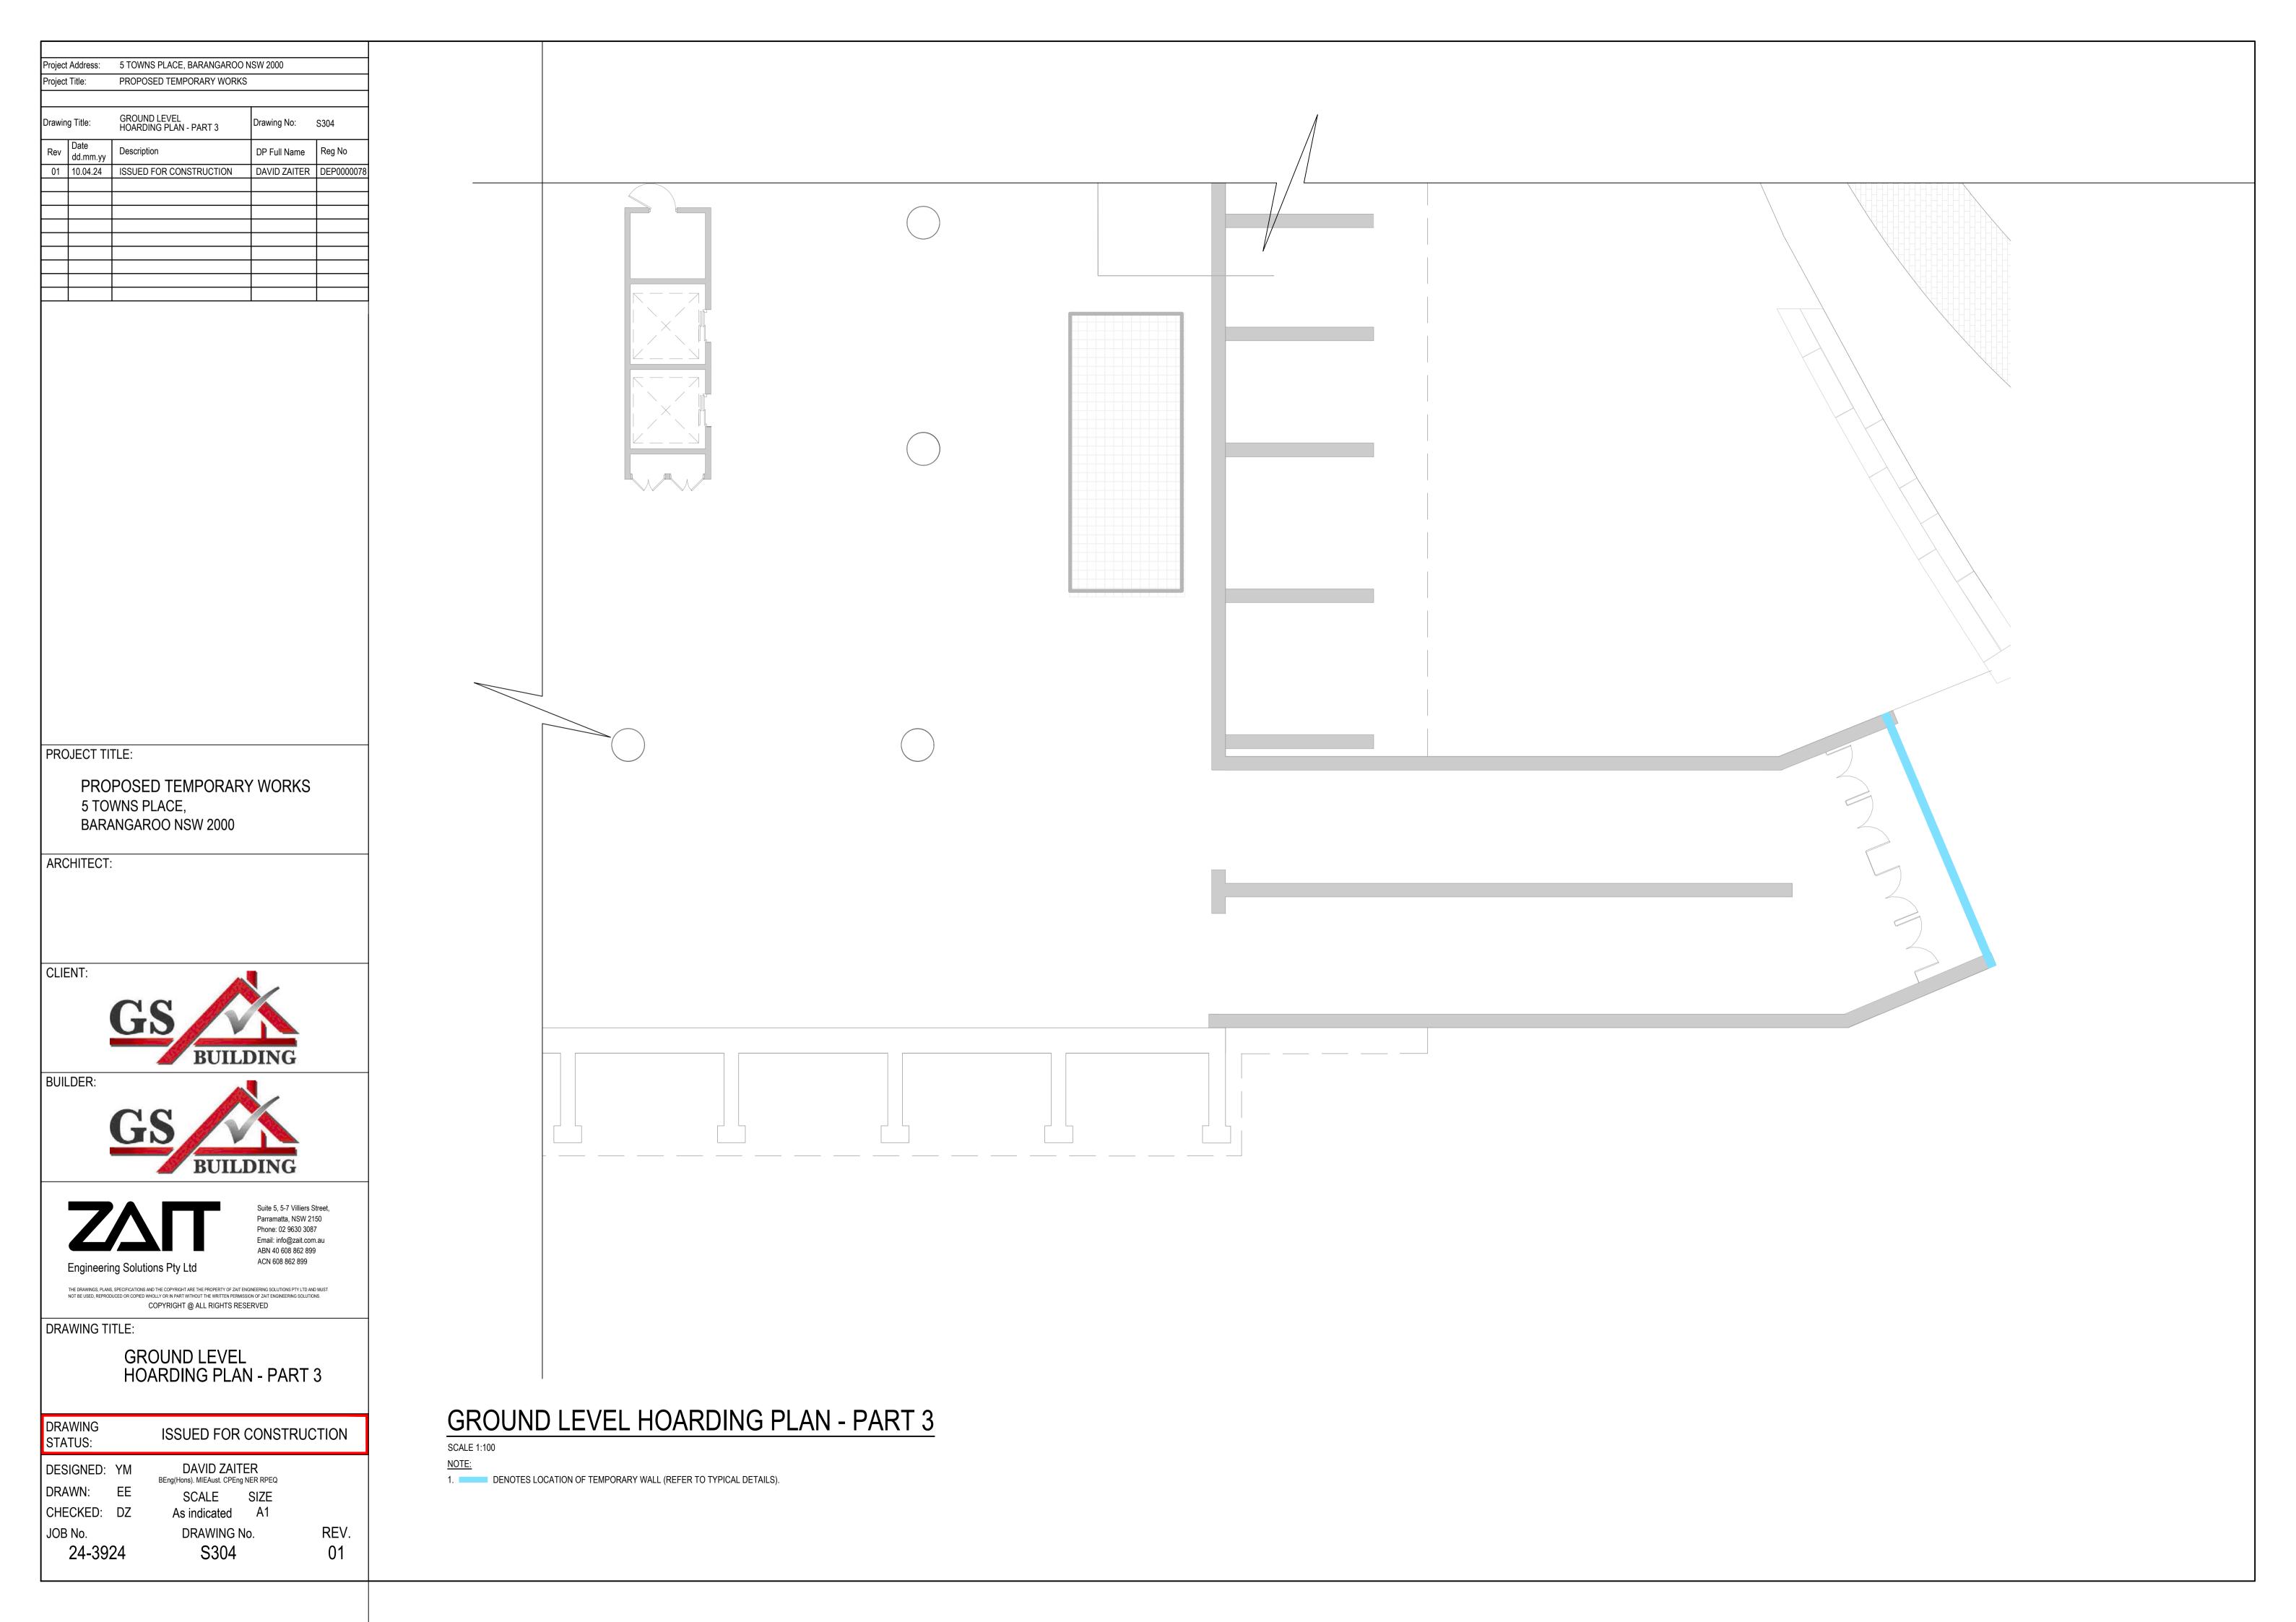

Project Address:		5 TOWNS PLACE, BARANGAROO NSW 2000					
Project Title:		PROPOSED TEMPORARY WORKS					
Drawin	ig Title:	GROUND LEVEL HOARDING DETAILS					
Rev Date dd.mm.yy		Description	DP Full Name	Reg No			
01	10.04.24	ISSUED FOR CONSTRUCTION	DAVID ZAITER	DEP0000078			
02	19.04.24	ISSUED FOR CONSTRUCTION	DAVID ZAITER	DEP0000078			

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ARCHITECT:

CLIENT:



BUILDER:





Phone: 02 9630 3087 Email: info@zait.com.au ABN 40 608 862 899 ACN 608 862 899 Engineering Solutions Pty Ltd

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DRAWING TITLE:

GROUND LEVEL HOARDING DETAILS

DRAWING STATUS:	
DESIGNED:	YM
DRAWN:	EE
CHECKED:	DZ

ISSUED FOR CONSTRUCTION

JOB No. 24-3924


DAVID ZAITER SCALE SIZE

REV. 02

Suite 5, 5-7 Villiers Street,

Parramatta, NSW 2150


BEng(Hons). MIEAust. CPEng NER RPEQ As indicated A1 DRAWING No. S305

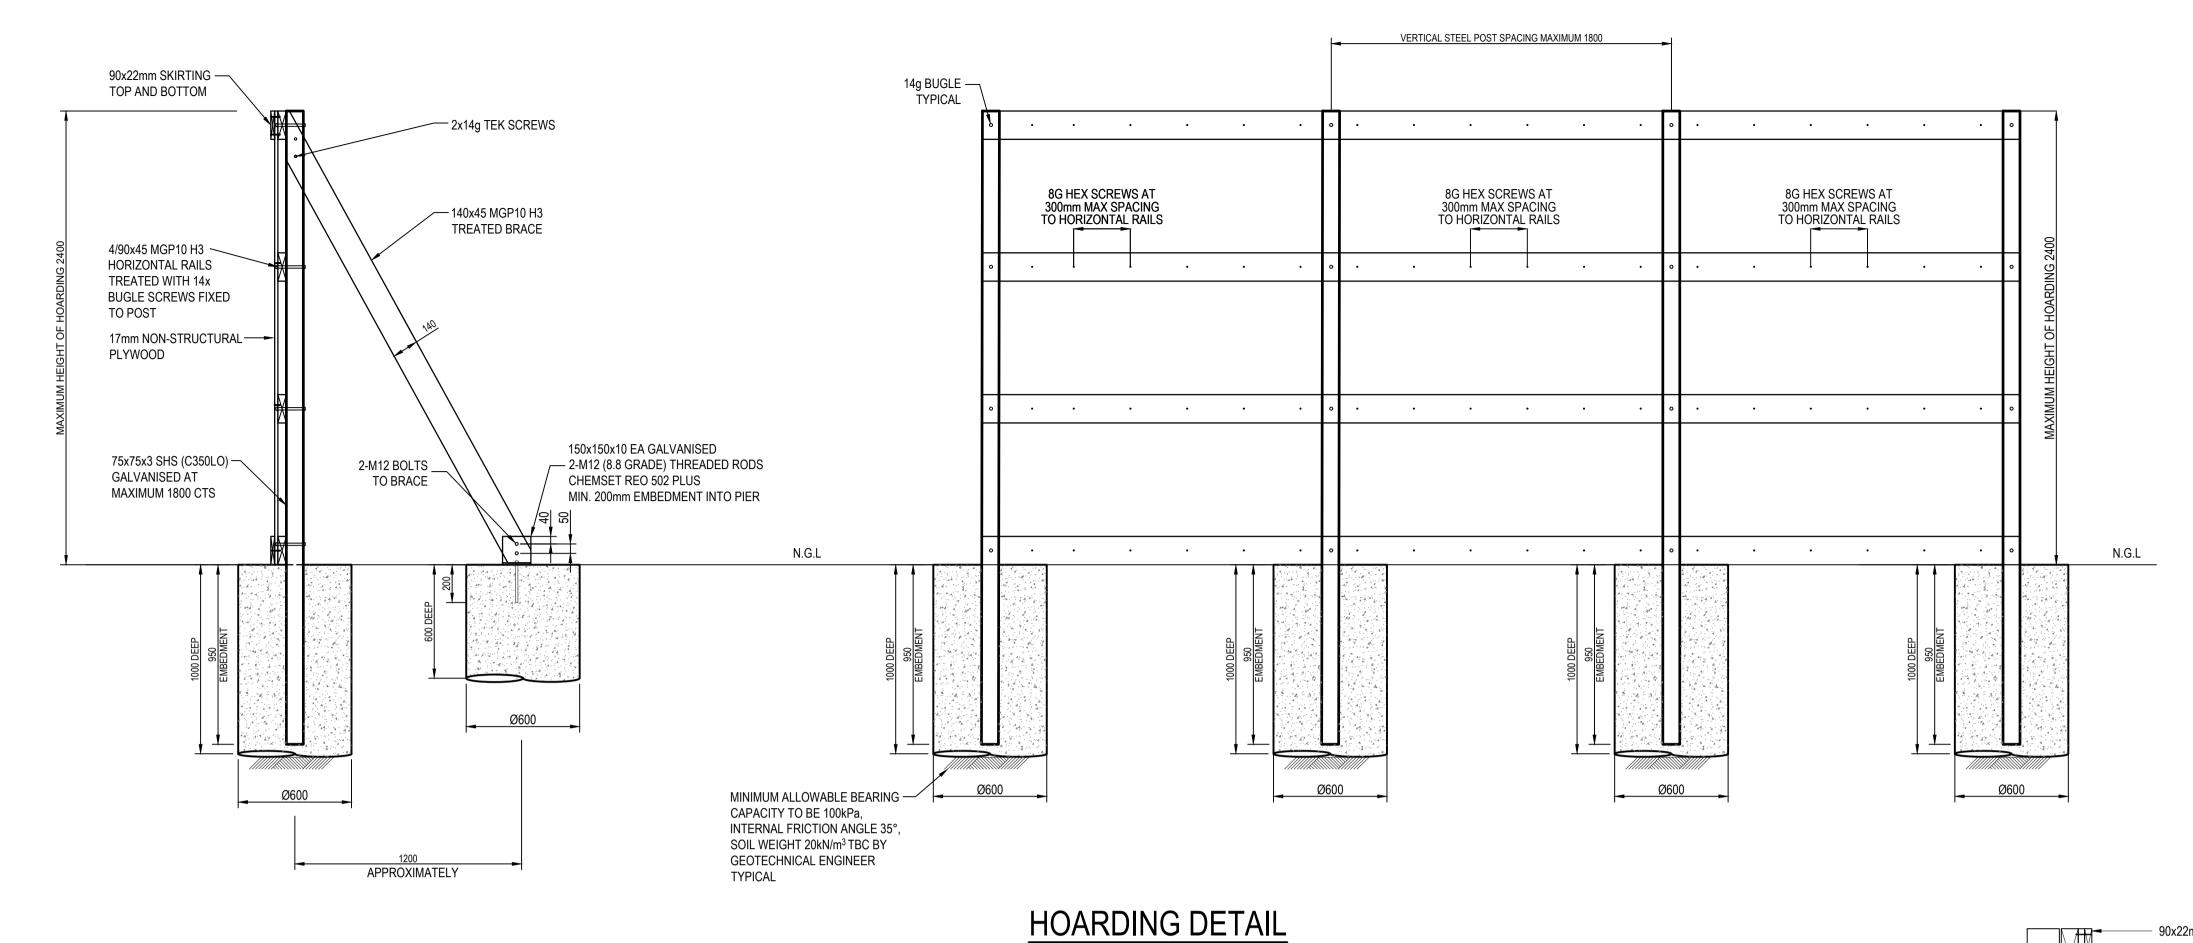

CONCRETE QUALITY				
ELEMENT	SLUMP	AGGREGATE (MAX. SIZE)	CEMENT TYPE	f'c
FOOTINGS	80mm	20mm	GP	32 MPa

NOTE : CARE TO BE TAKEN DURING EXCAVATION TO AVOID DAMAGE TO EXISTING SERVICES. REFER TO SERVICES PEGOUT REPORT



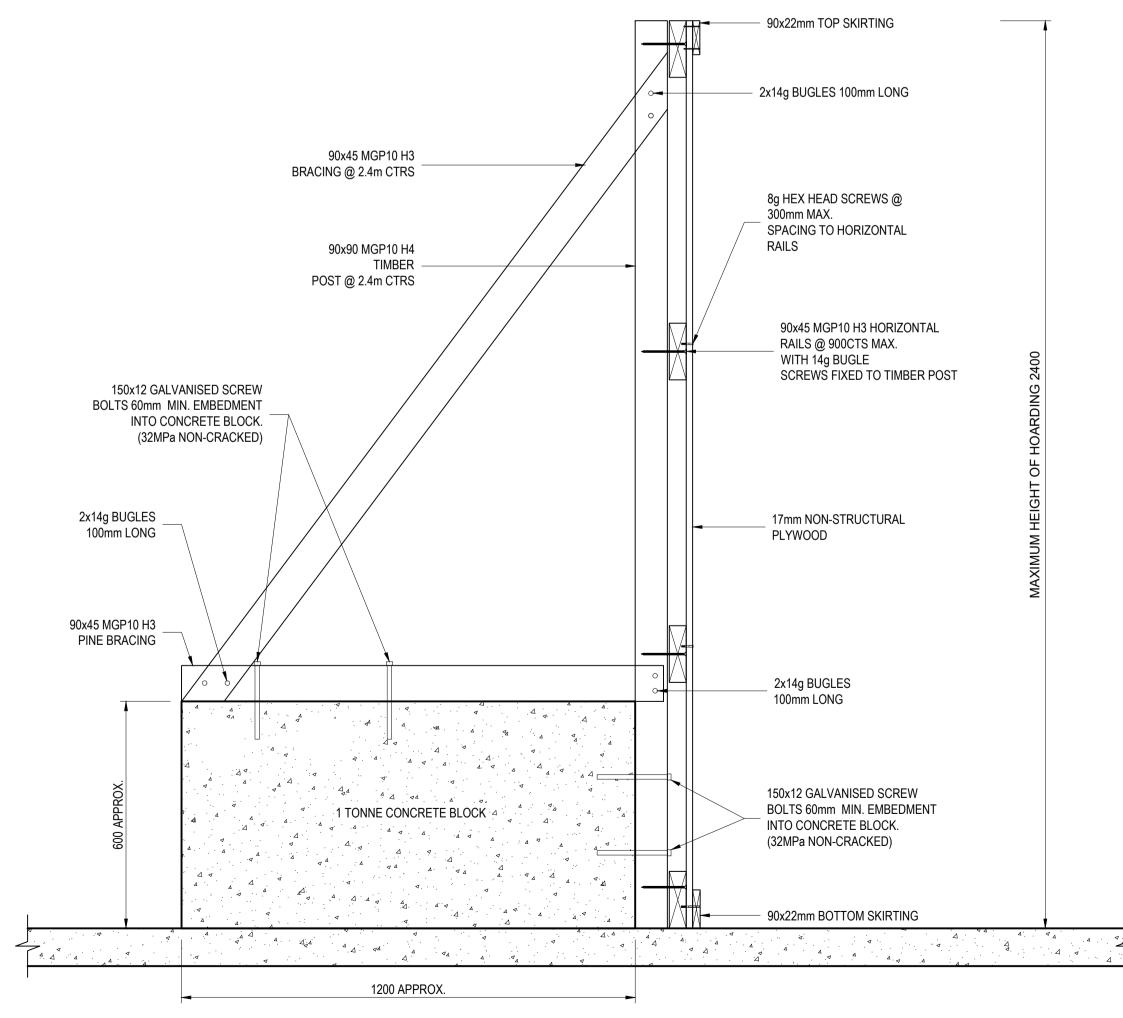

### 1 TONNE CONCRETE BLOCK HOARDING

SCALE 1:10

DO NOT UNDERMINE **EXISTING FOOTINGS DURING TRENCH ECAVATIONS** 

Project Address:		5 TOWNS PLACE, BARANGAROO NSW 2000					
Project Title:		PROPOSED TEMPORARY WORKS					
Drawin	g Title:	GROUND FLOOR TEMPORARY WALL DETAILS	Drawing No: S306				
Rev	Date dd.mm.yy	Description	DP Full Name	Reg No			
01	10.04.24	ISSUED FOR CONSTRUCTION	DAVID ZAITER	DEP0000078			
02	19.04.24	ISSUED FOR CONSTRUCTION	DAVID ZAITER	DEP0000078			

PROPOSED TEMPORARY WORKS 5 TOWNS PLACE, BARANGAROO NSW 2000

ARCHITECT:

CLIENT:



BUILDER:





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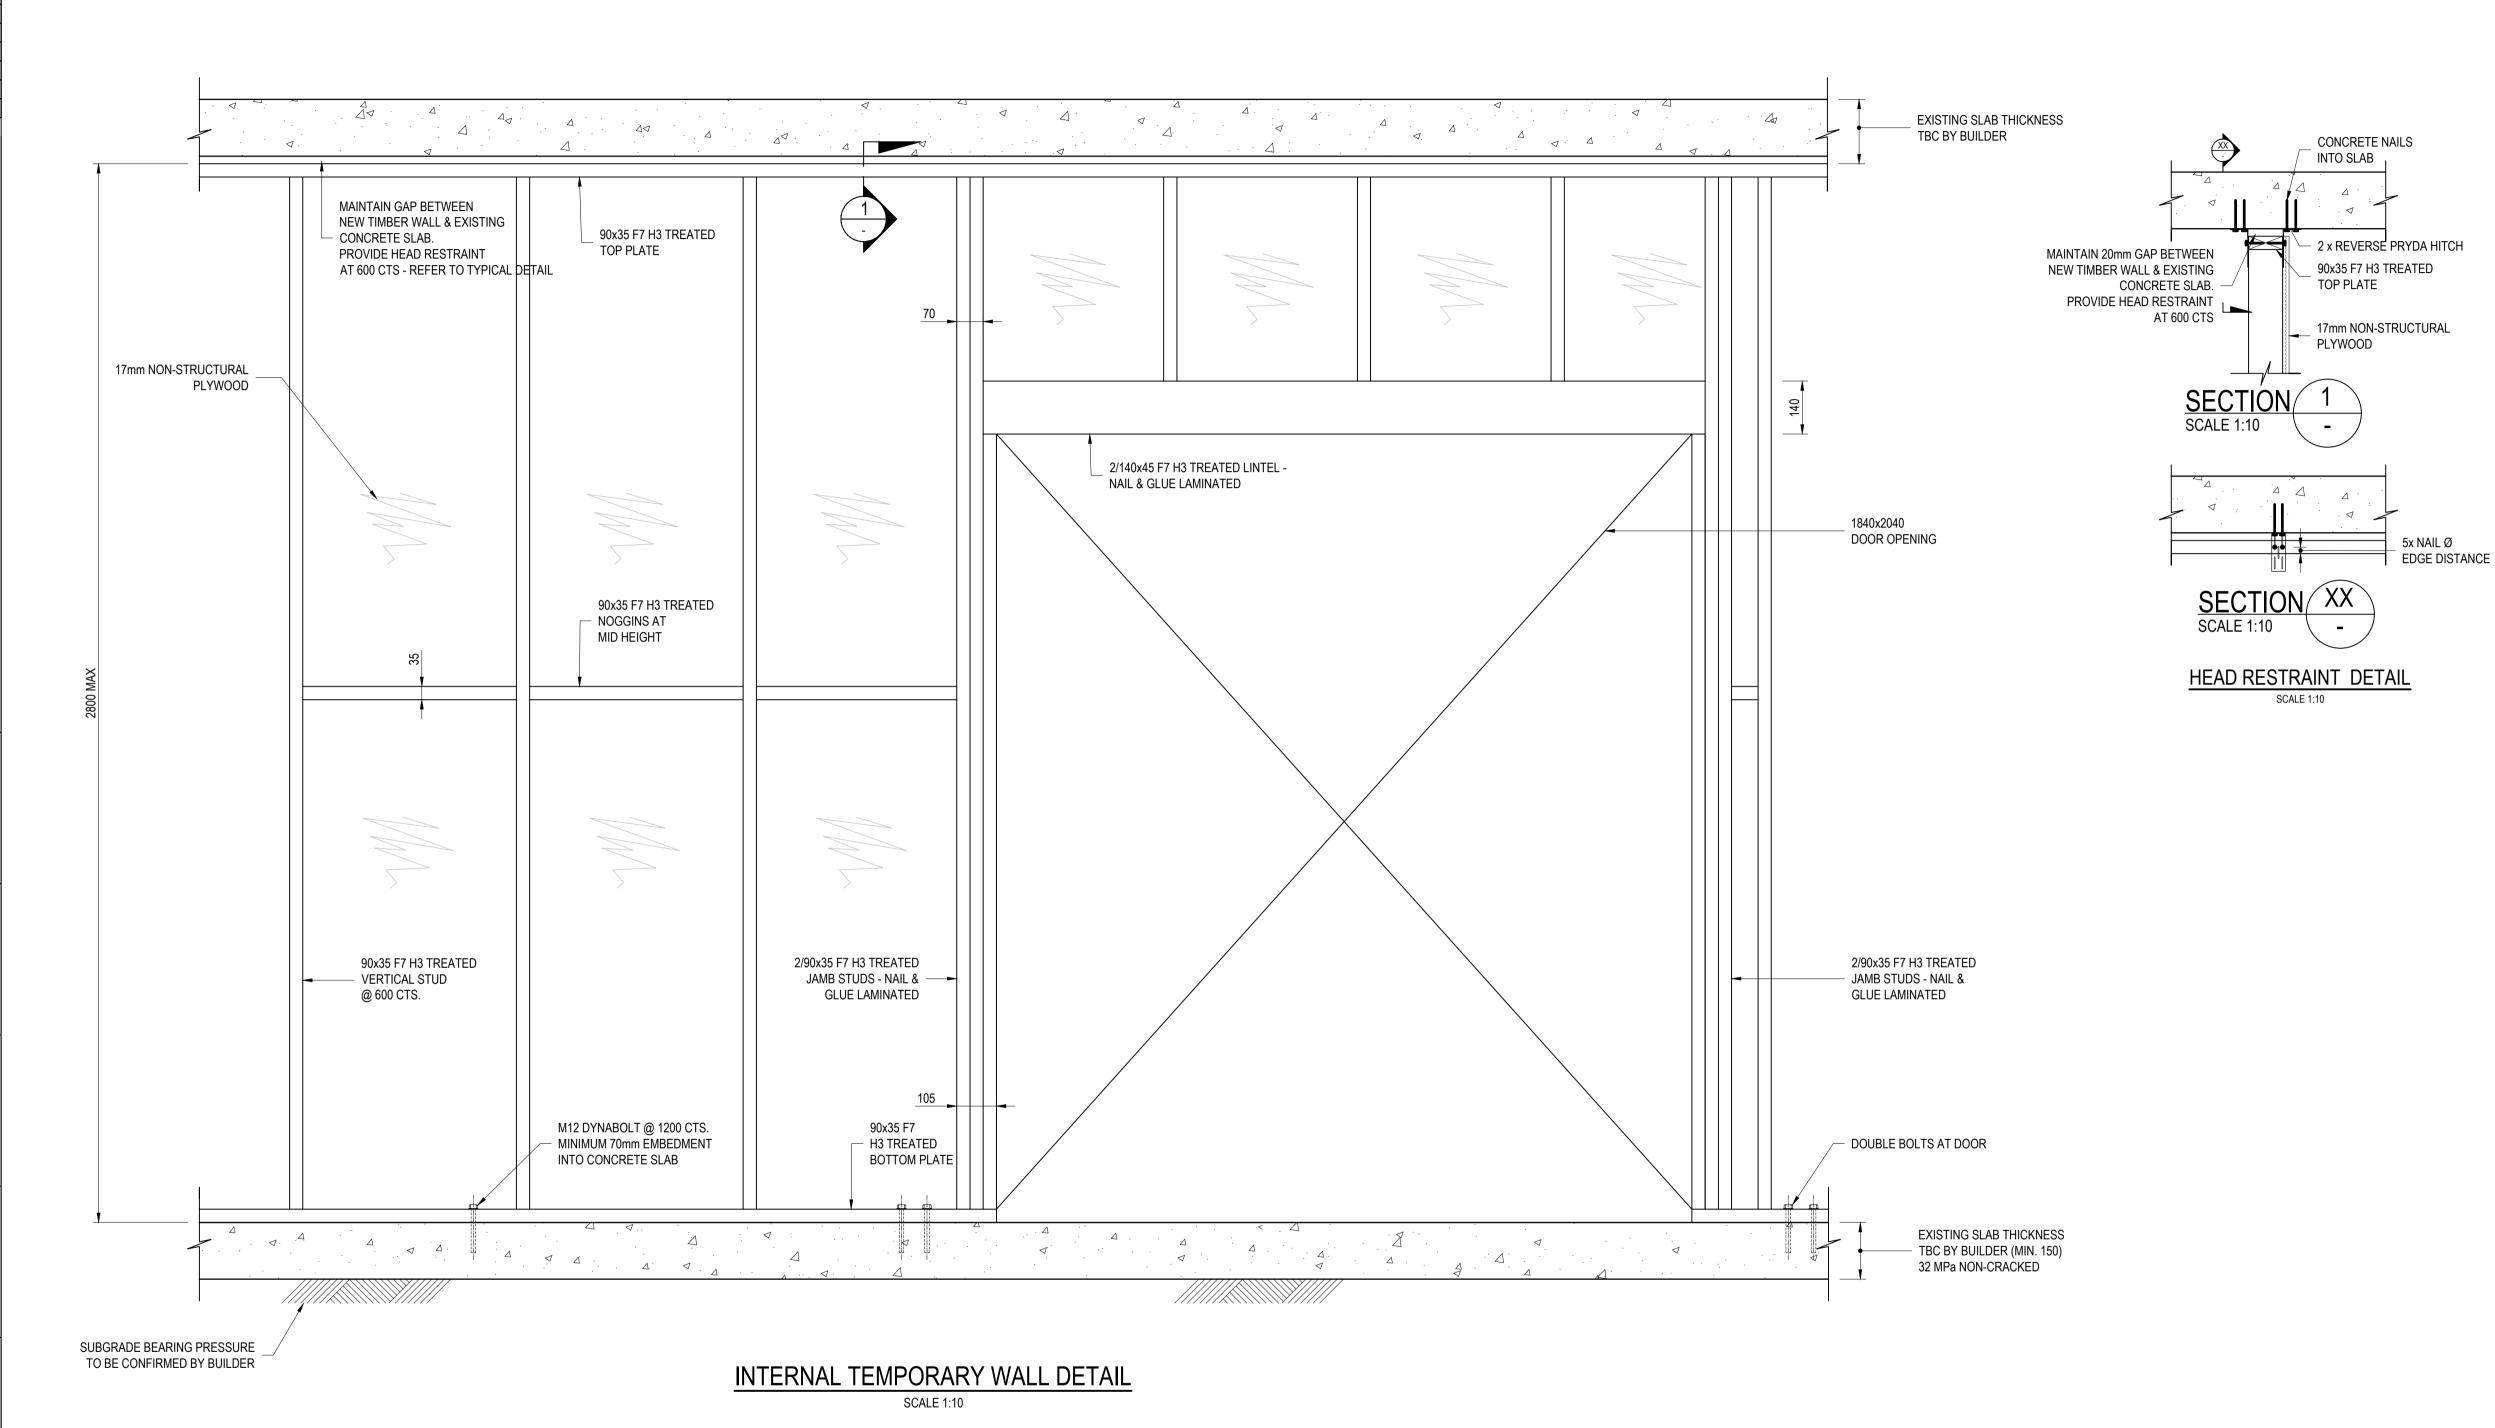
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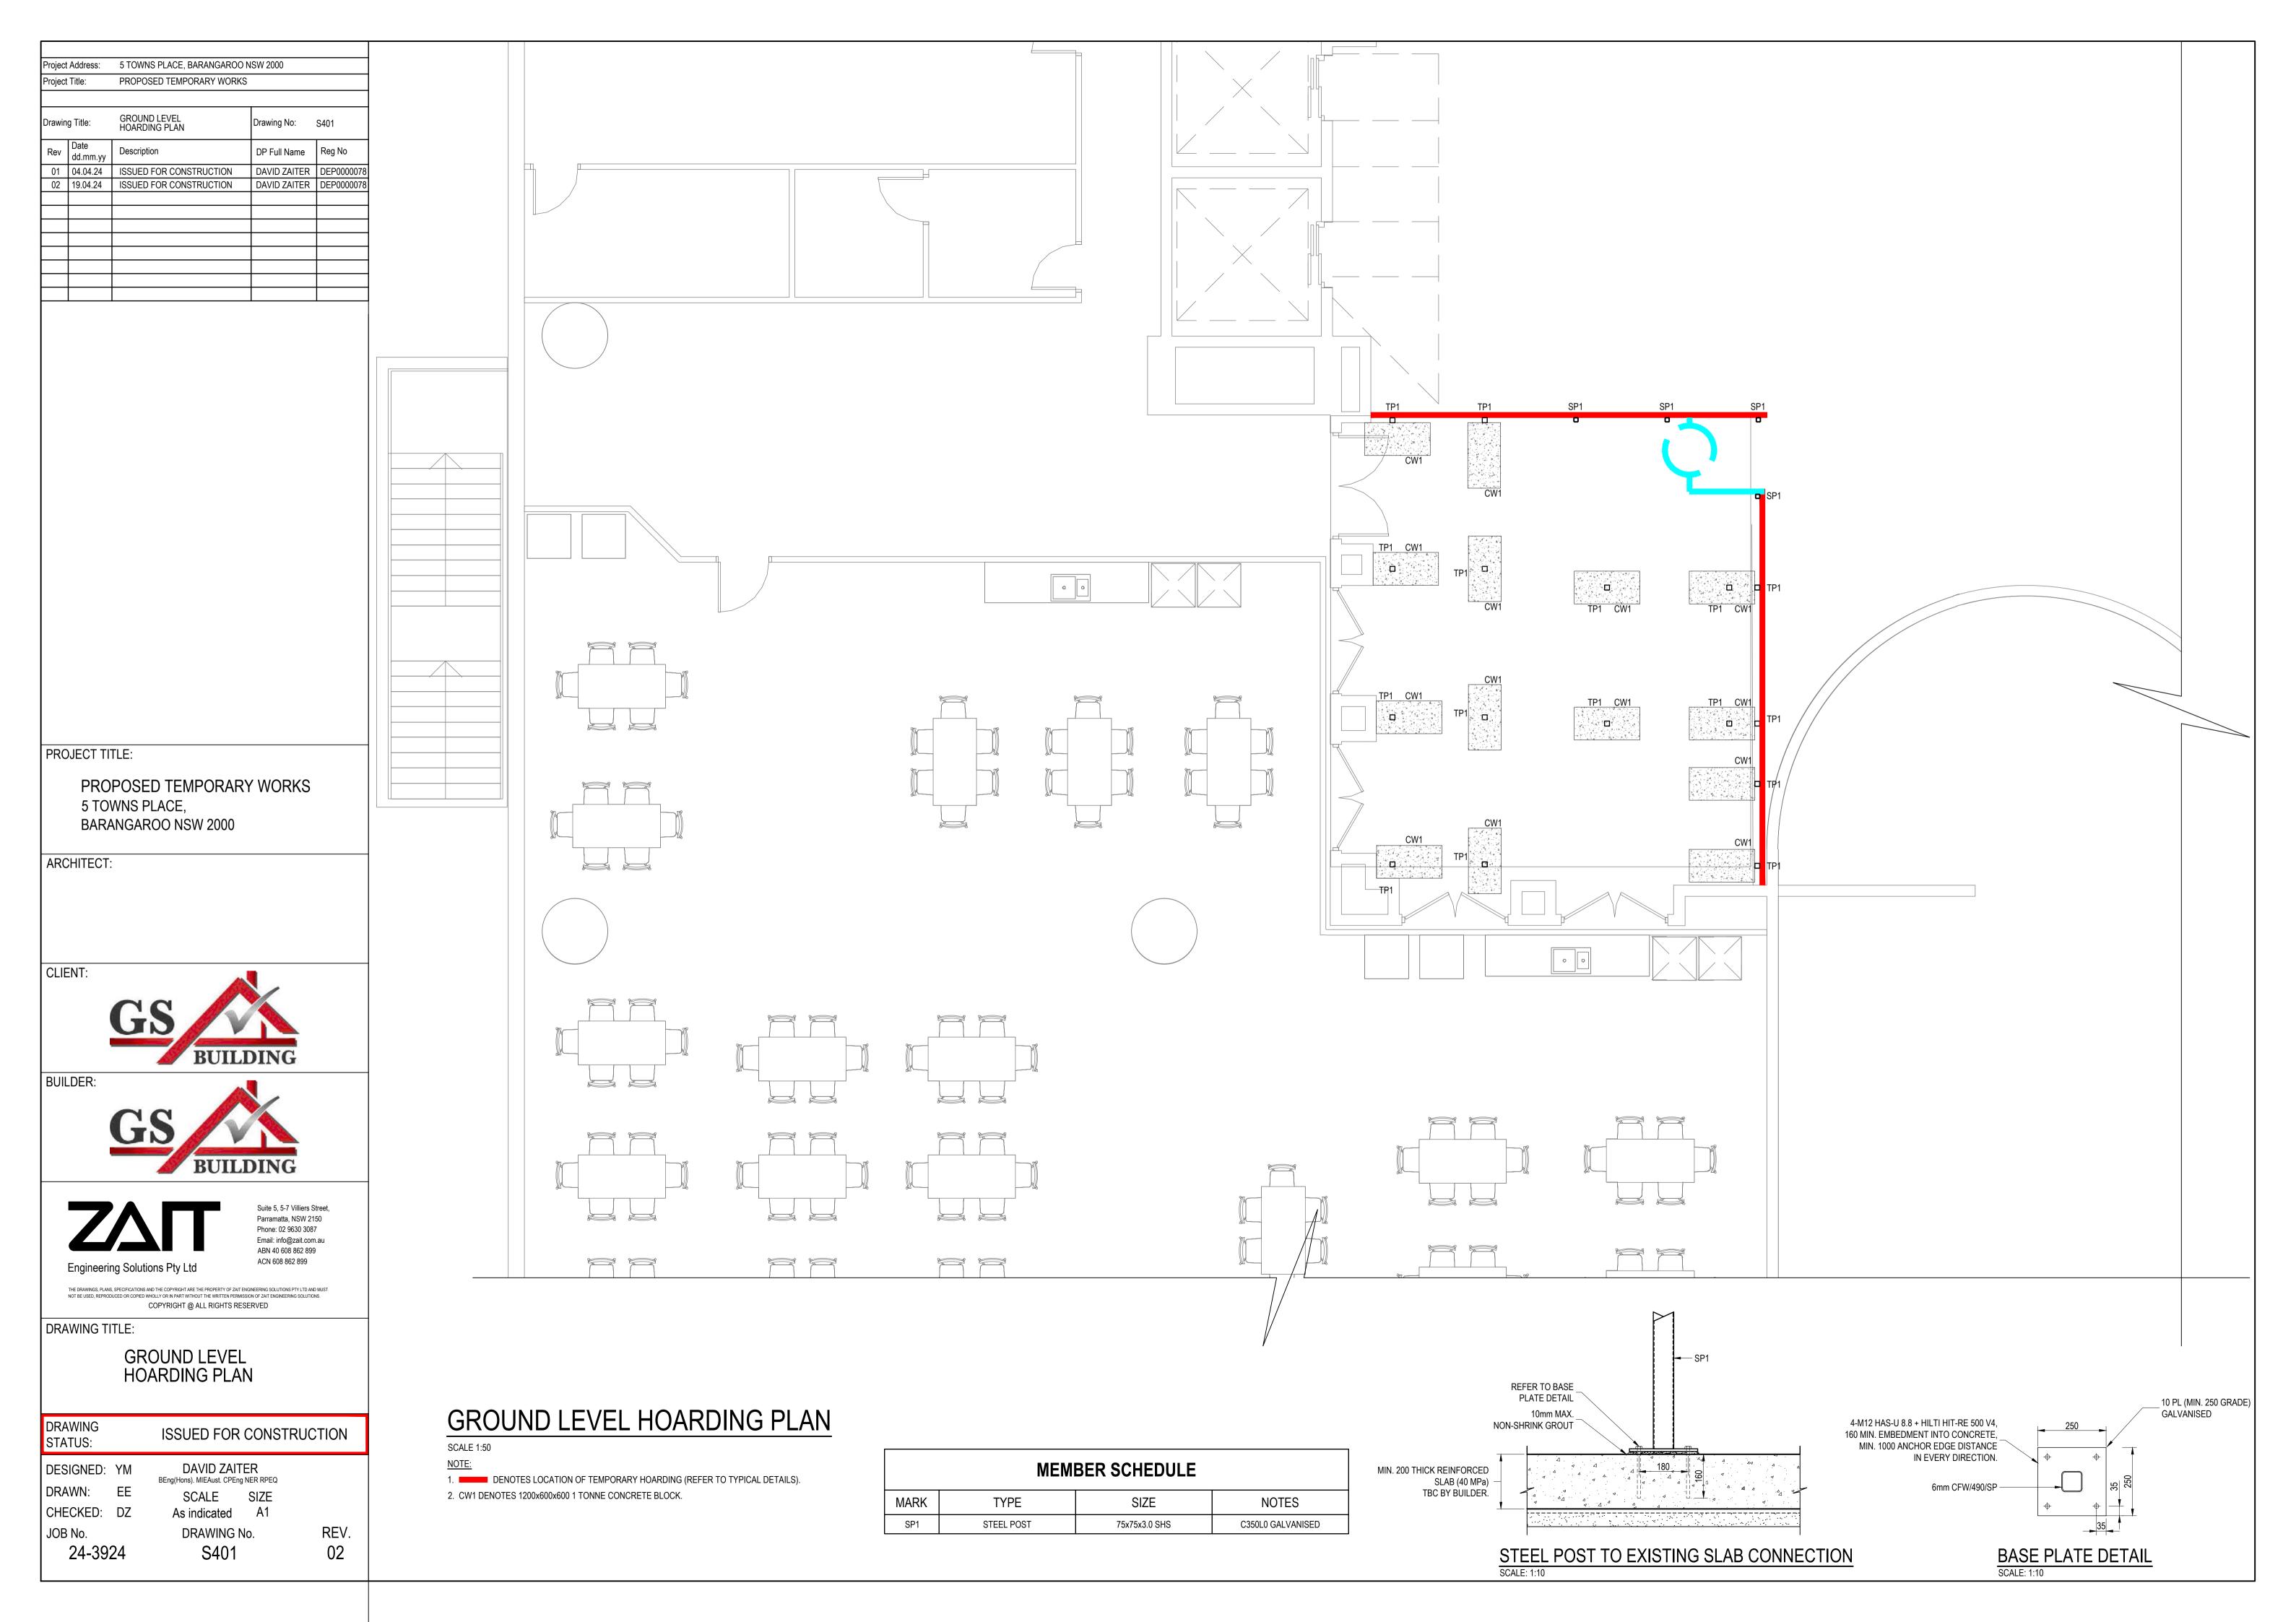
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DRAWING TITLE:

**GROUND FLOOR** TEMPORARY WALL DETAILS

DRAWING STATUS:		ISSUED FOR CONSTRUC	CTION
DESIGNED: DRAWN: CHECKED:	EE	DAVID ZAITER BEng(Hons). MIEAust. CPEng NER RPEQ SCALE SIZE As indicated A1	
JOB No. <b>24-39</b> ;		DRAWING No. \$306	REV.





Project Address:		5 TOWNS PLACE, BARANGAROO NSW 2000			
Project Title:		PROPOSED TEMPORARY WORKS			
Drawing Title:		GROUND LEVEL HOARDING DETAILS	Drawing No: S402		
Rev	Date dd.mm.yy	Description	DP Full Name	Reg No	
01	04.04.24	ISSUED FOR CONSTRUCTION	DAVID ZAITER	DEP0000078	
02	10.04.24	ISSUED FOR CONSTRUCTION	DAVID ZAITER	DEP0000078	

PROPOSED TEMPORARY WORKS 5 TOWNS PLACE, BARANGAROO NSW 2000

ARCHITECT:

CLIENT:



BUILDER:





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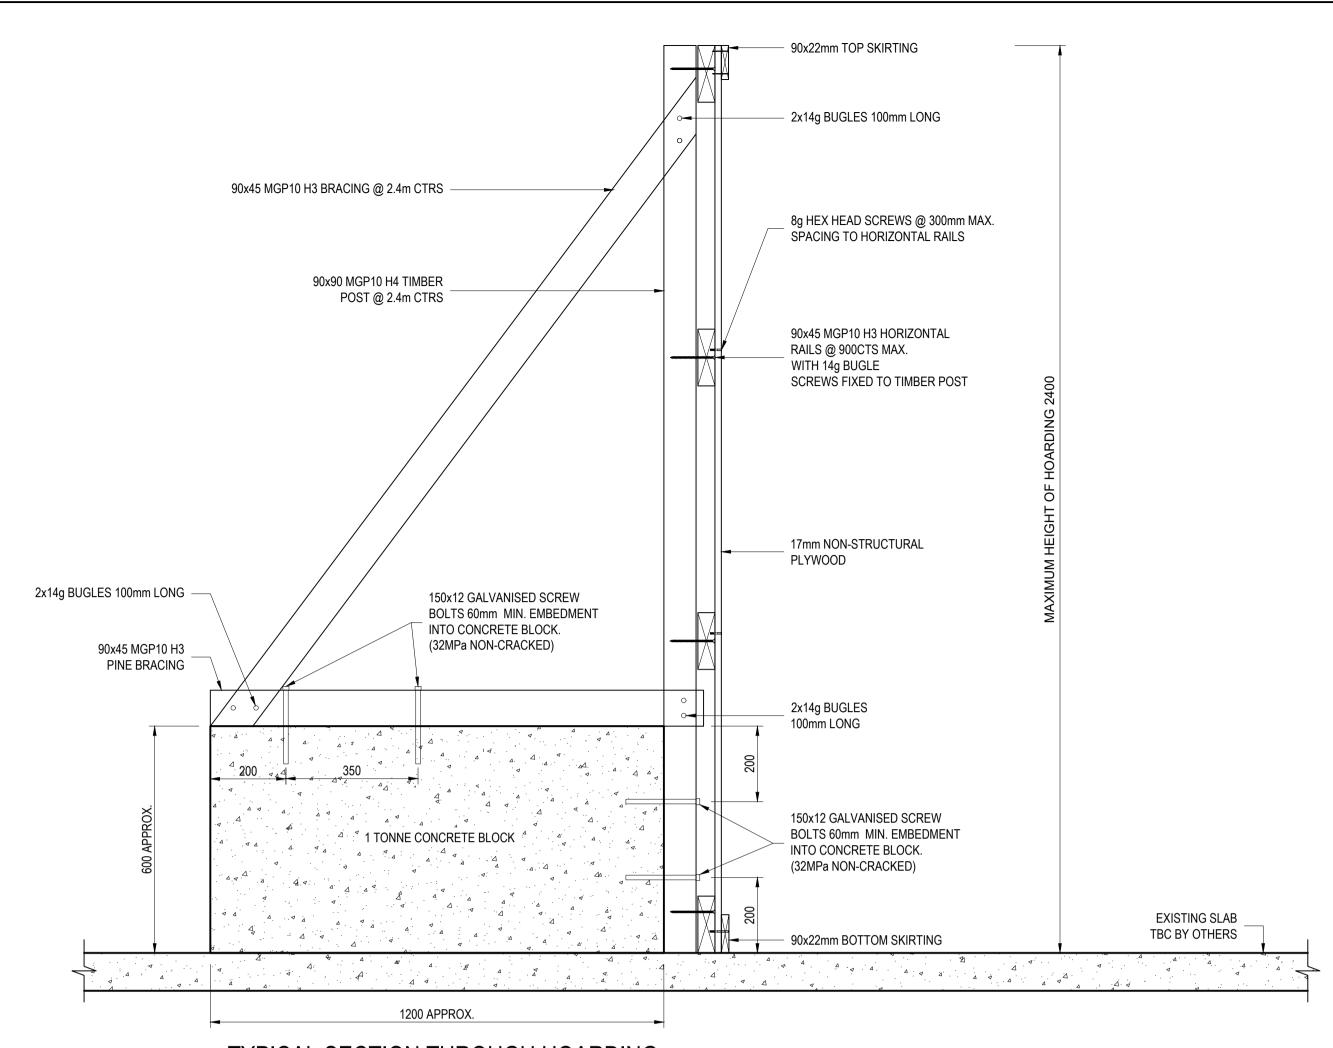
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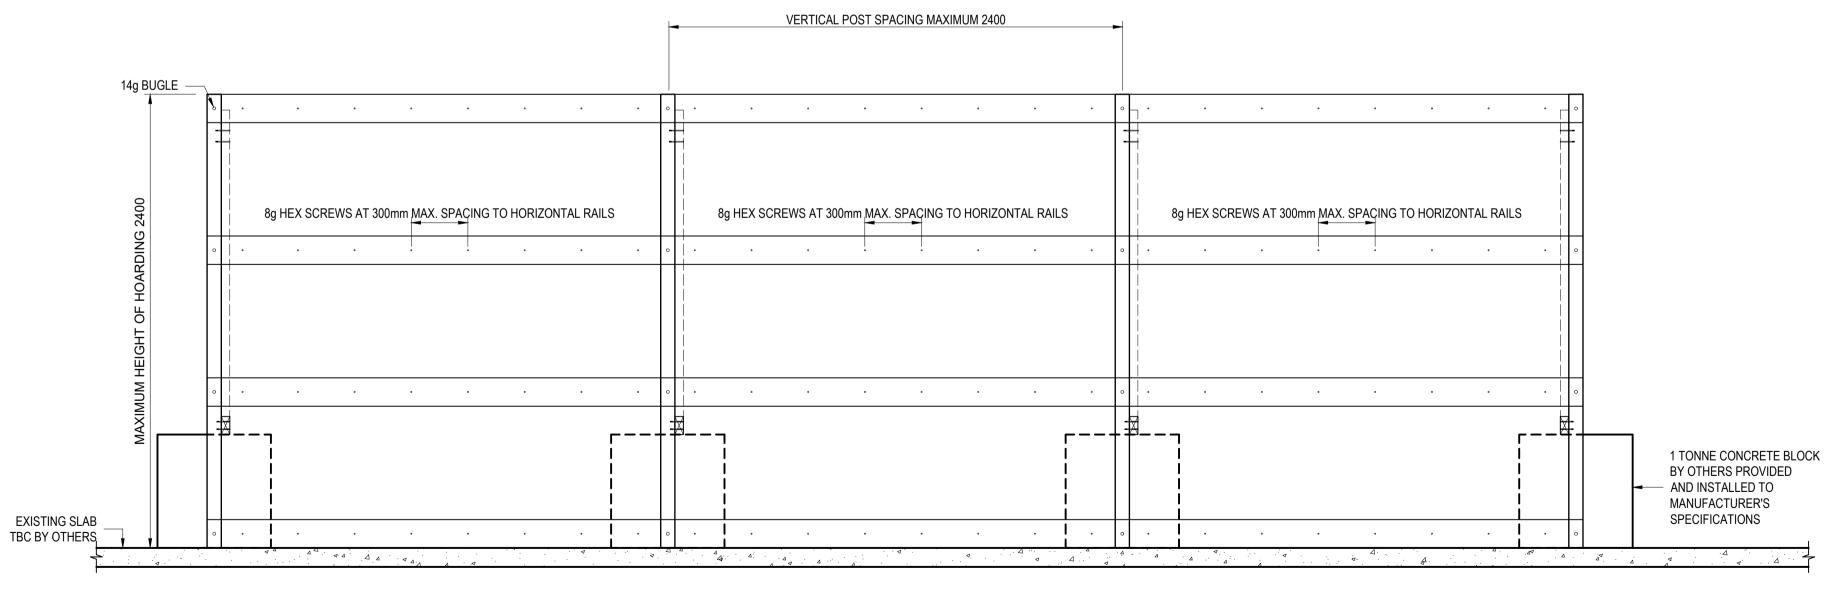
DRAWING TITLE:

GROUND LEVEL HOARDING DETAILS


DRAWING STATUS:		ISSUED FOR CONSTRU	CTION
DESIGNED:	ΥM	DAVID ZAITER BEng(Hons), MIEAust, CPEng NER RPEQ	
DRAWN:	EE	SCALE SIZE	
CHECKED:	DZ	As indicated A1	
JOB No.		DRAWING No.	REV.
24-3924		S402	01



TYPICAL SECTION THROUGH HOARDING
SCALE 1:10



TYPICAL HOARDING ELEVATION ON 1 TONNE CONCRETE BLOCK

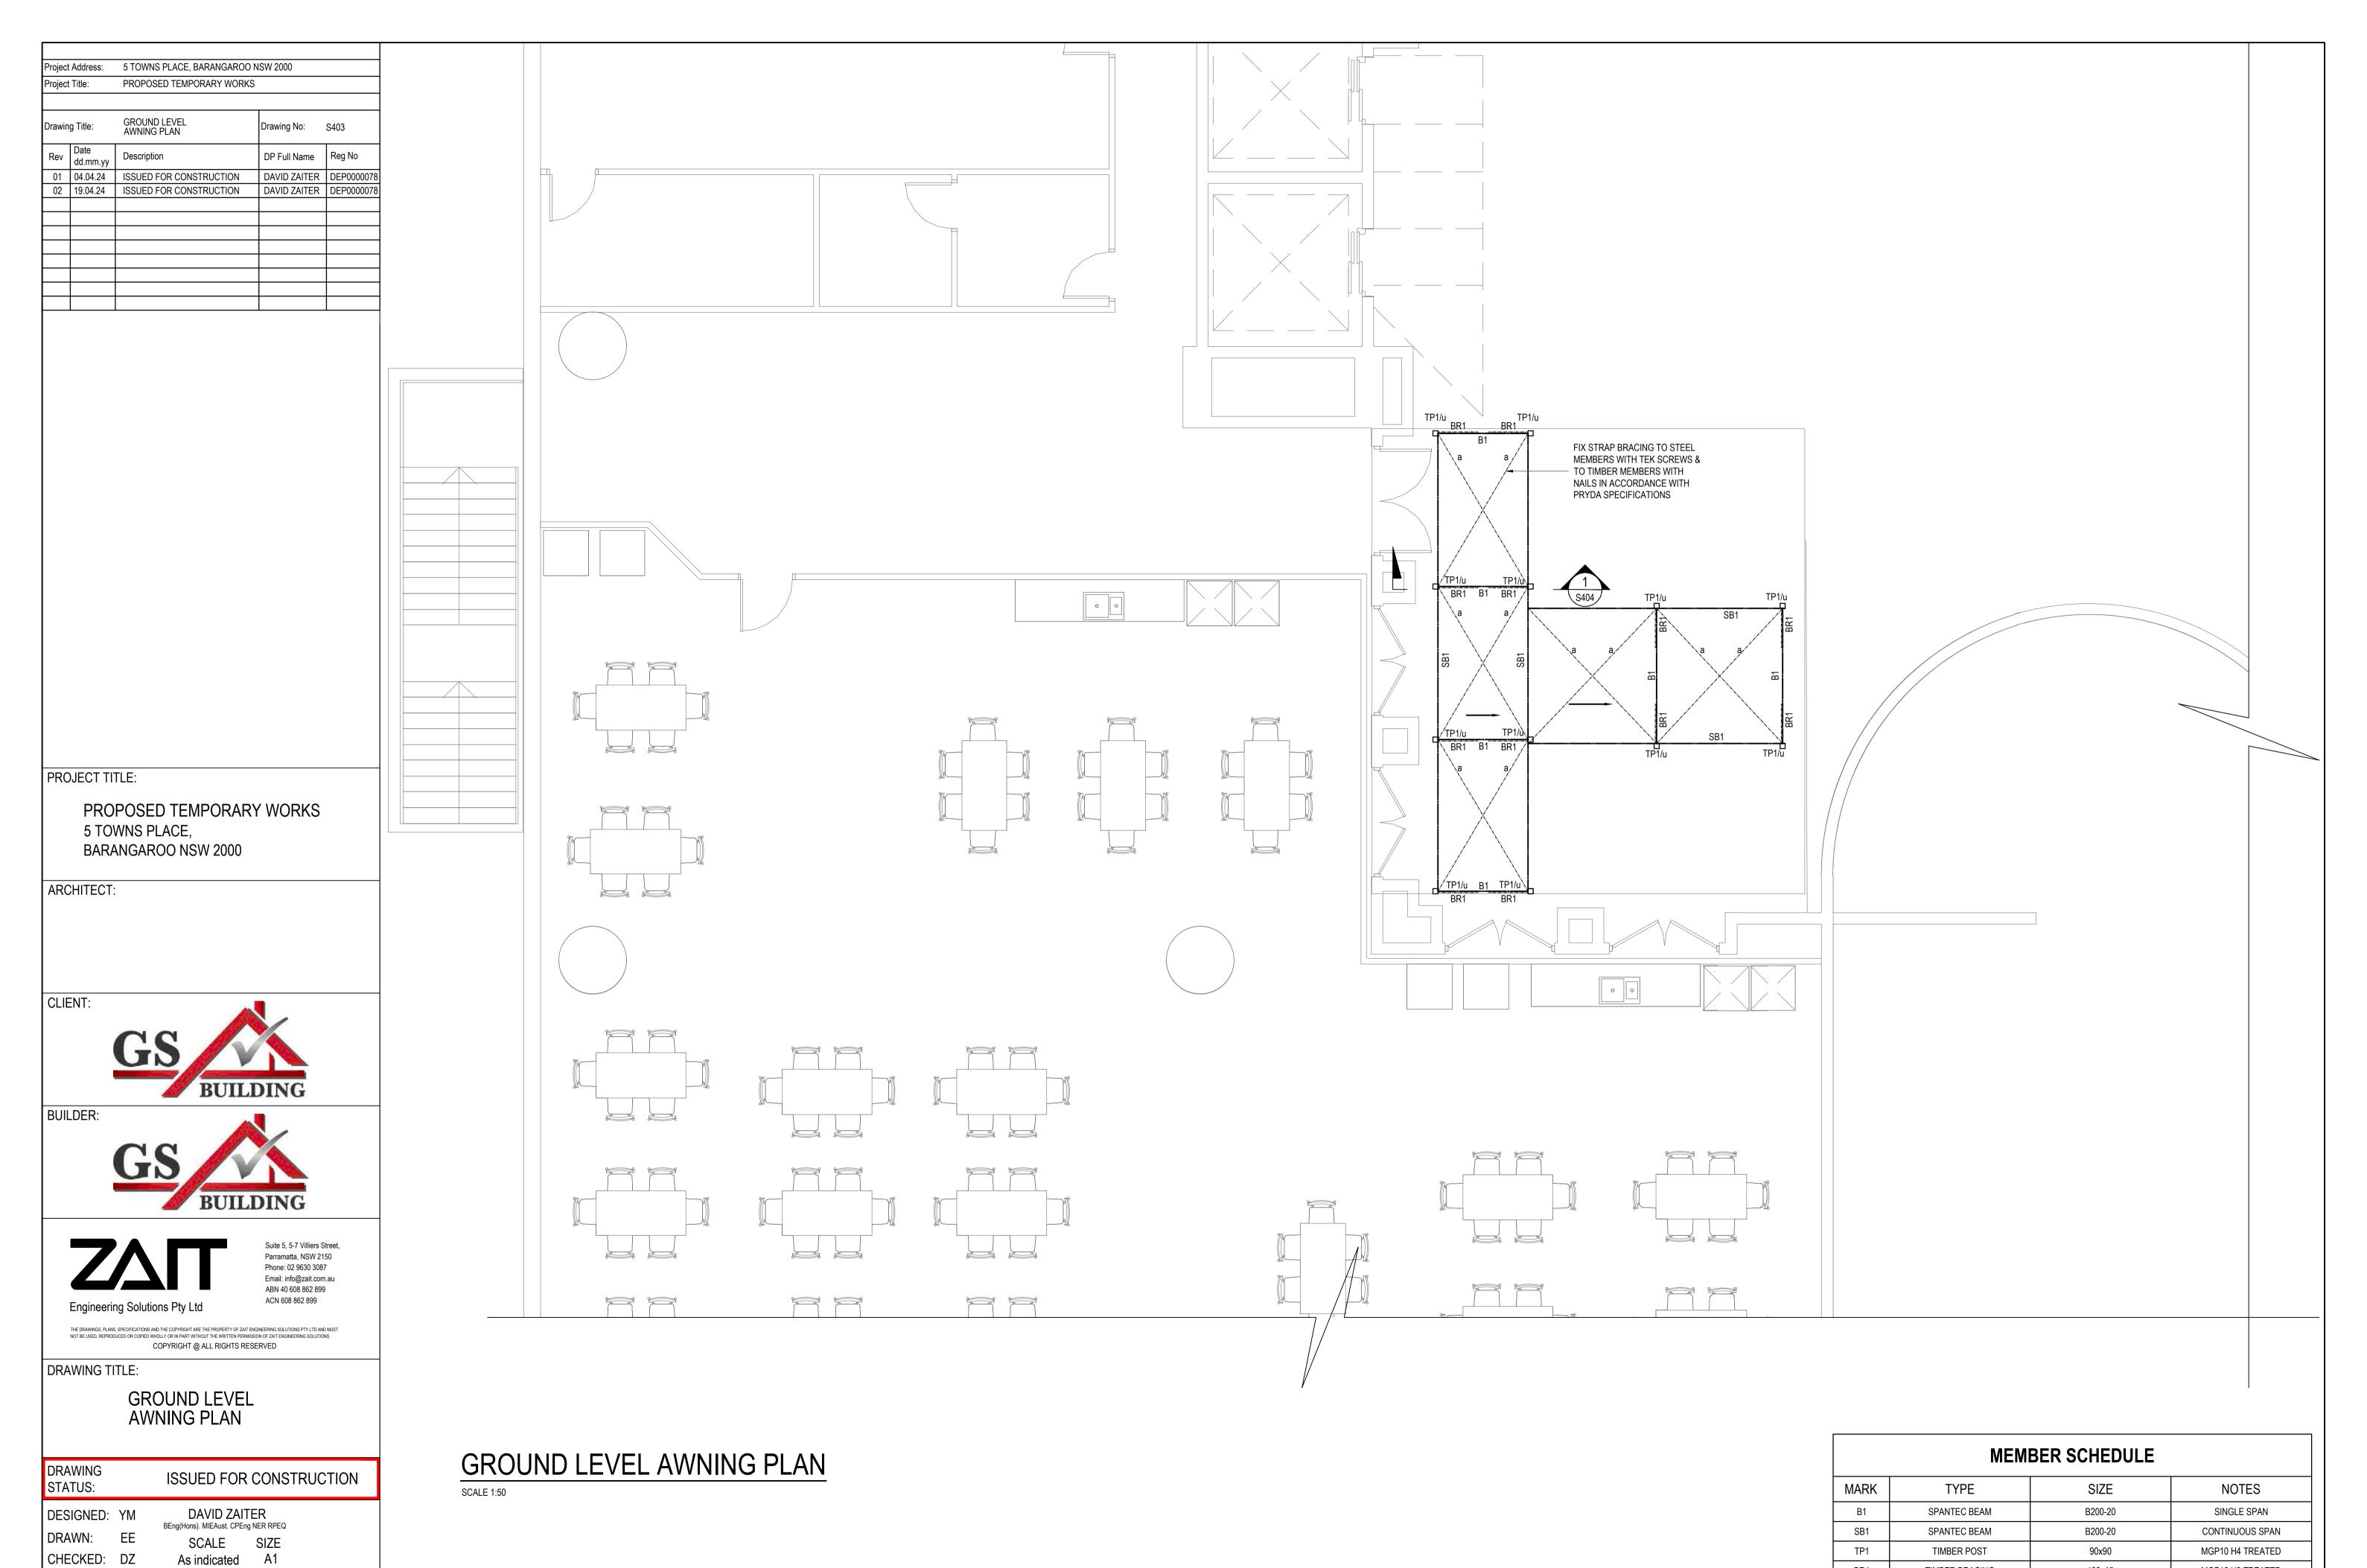

JOB No.

24-3924

REV.

DRAWING No.

S403

MGP10 H3 TREATED

300 GRADE

TIMBER BRACING

ROOF STRAP BRACING

190x45

30x1.2mm STRAP BRACING

Project	t Address:	5 TOWNS PLACE, BARANGAROO NSW 2000			
Project Title:		PROPOSED TEMPORARY WORK	S		
Drawing Title:		GROUND LEVEL SECTIONS & DETAILS	Drawing No: S404		
Rev	Date dd.mm.yy	Description	DP Full Name	Reg No	
01	04.04.24	ISSUED FOR CONSTRUCTION	DAVID ZAITER	DEP0000078	
02	19.04.24	ISSUED FOR CONSTRUCTION	DAVID ZAITER	DEP0000078	

PROPOSED TEMPORARY WORKS 5 TOWNS PLACE, BARANGAROO NSW 2000

ARCHITECT:

CLIENT:



BUILDER:





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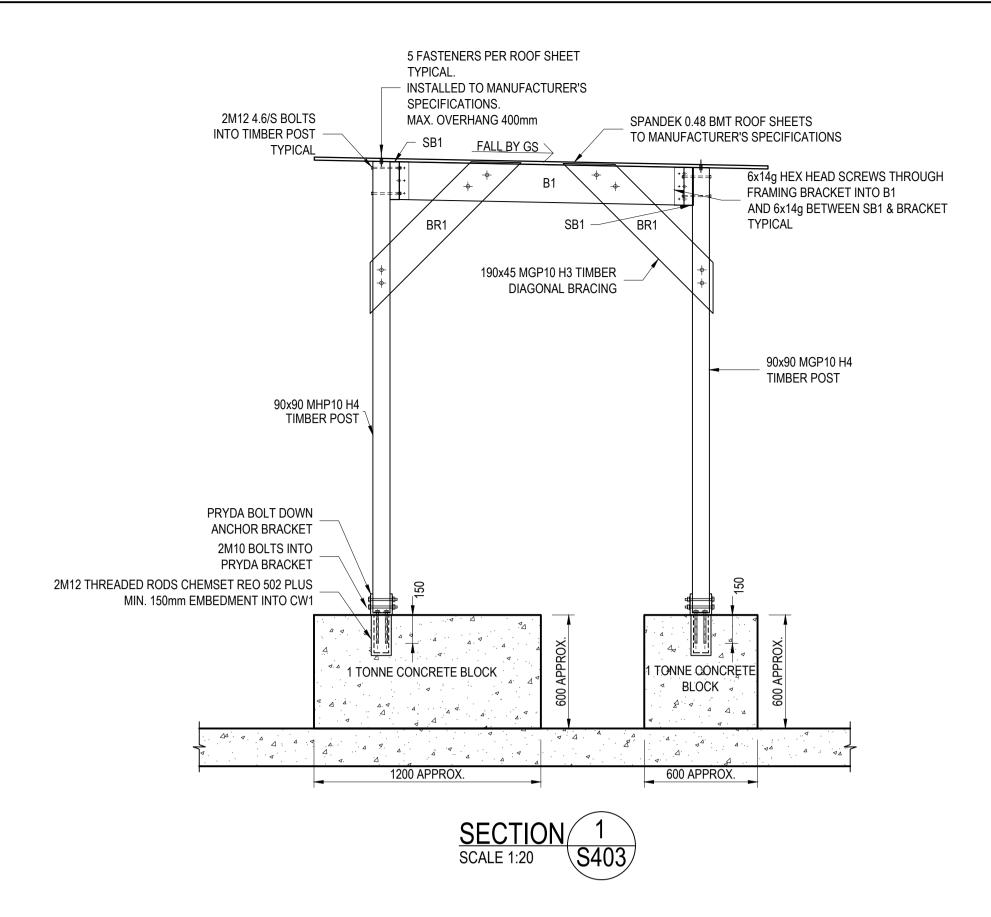
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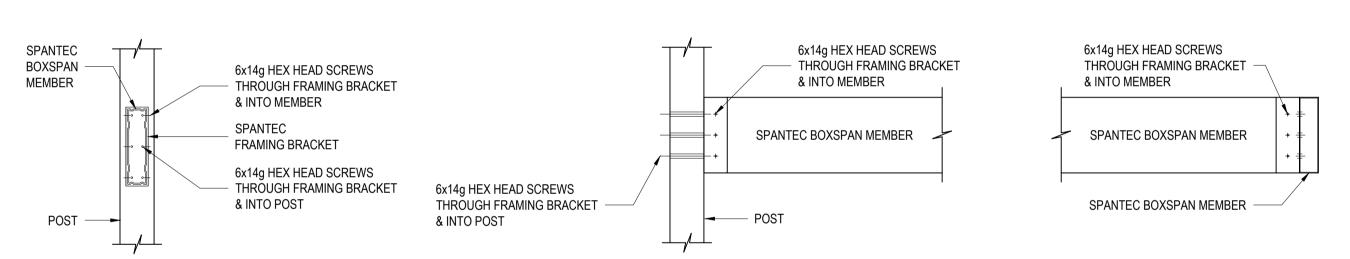
DRAWING TITLE:

DRAWING

GROUND LEVEL SECTIONS & DETAILS


DRAWING STATUS:	ISSUED FOR CONS	TRUCTION
DESIGNED: YM	DAVID ZAITER BEng(Hons). MIEAust. CPEng NER RPEQ	
DRAWN: EI	SCALE SIZE	
CHECKED: D	Z As indicated A1	
JOB No.	DRAWING No.	REV.
24-3924	S404	02






TYPICAL FRAMING BRACKET TO POST CONNECTION DETAIL

TYPICAL FRAMING BRACKET CONNECTION DETAIL

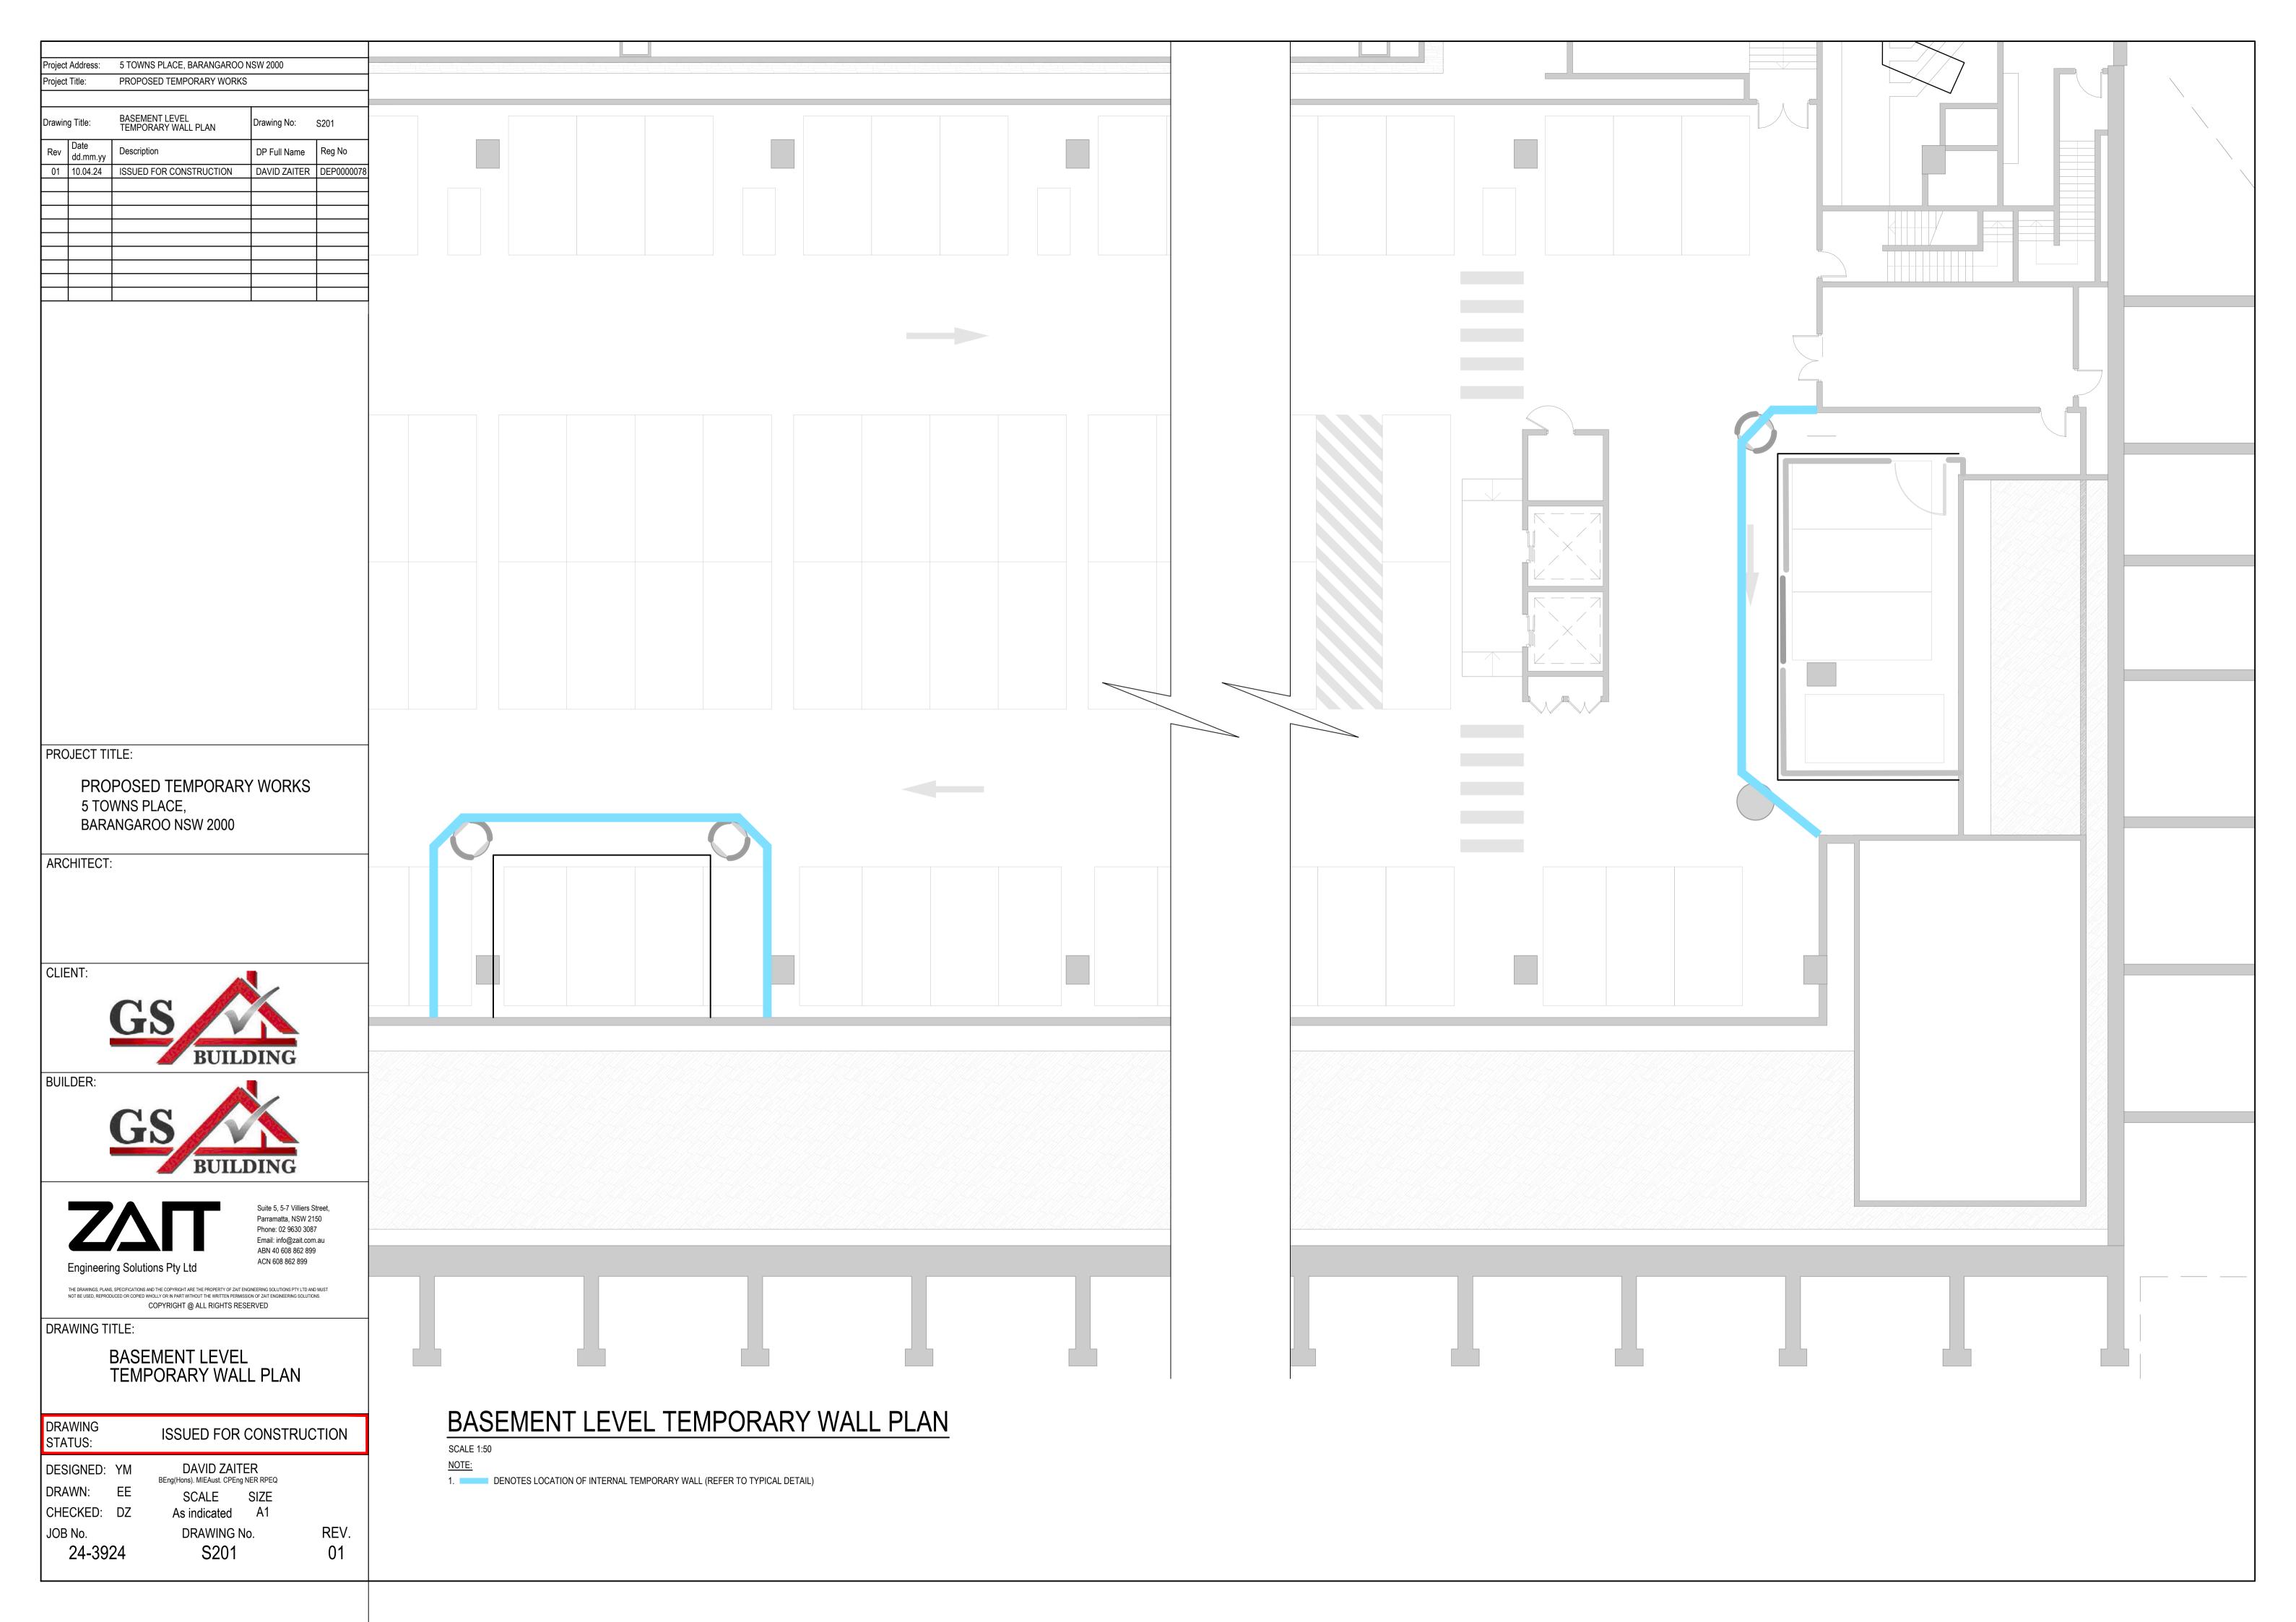

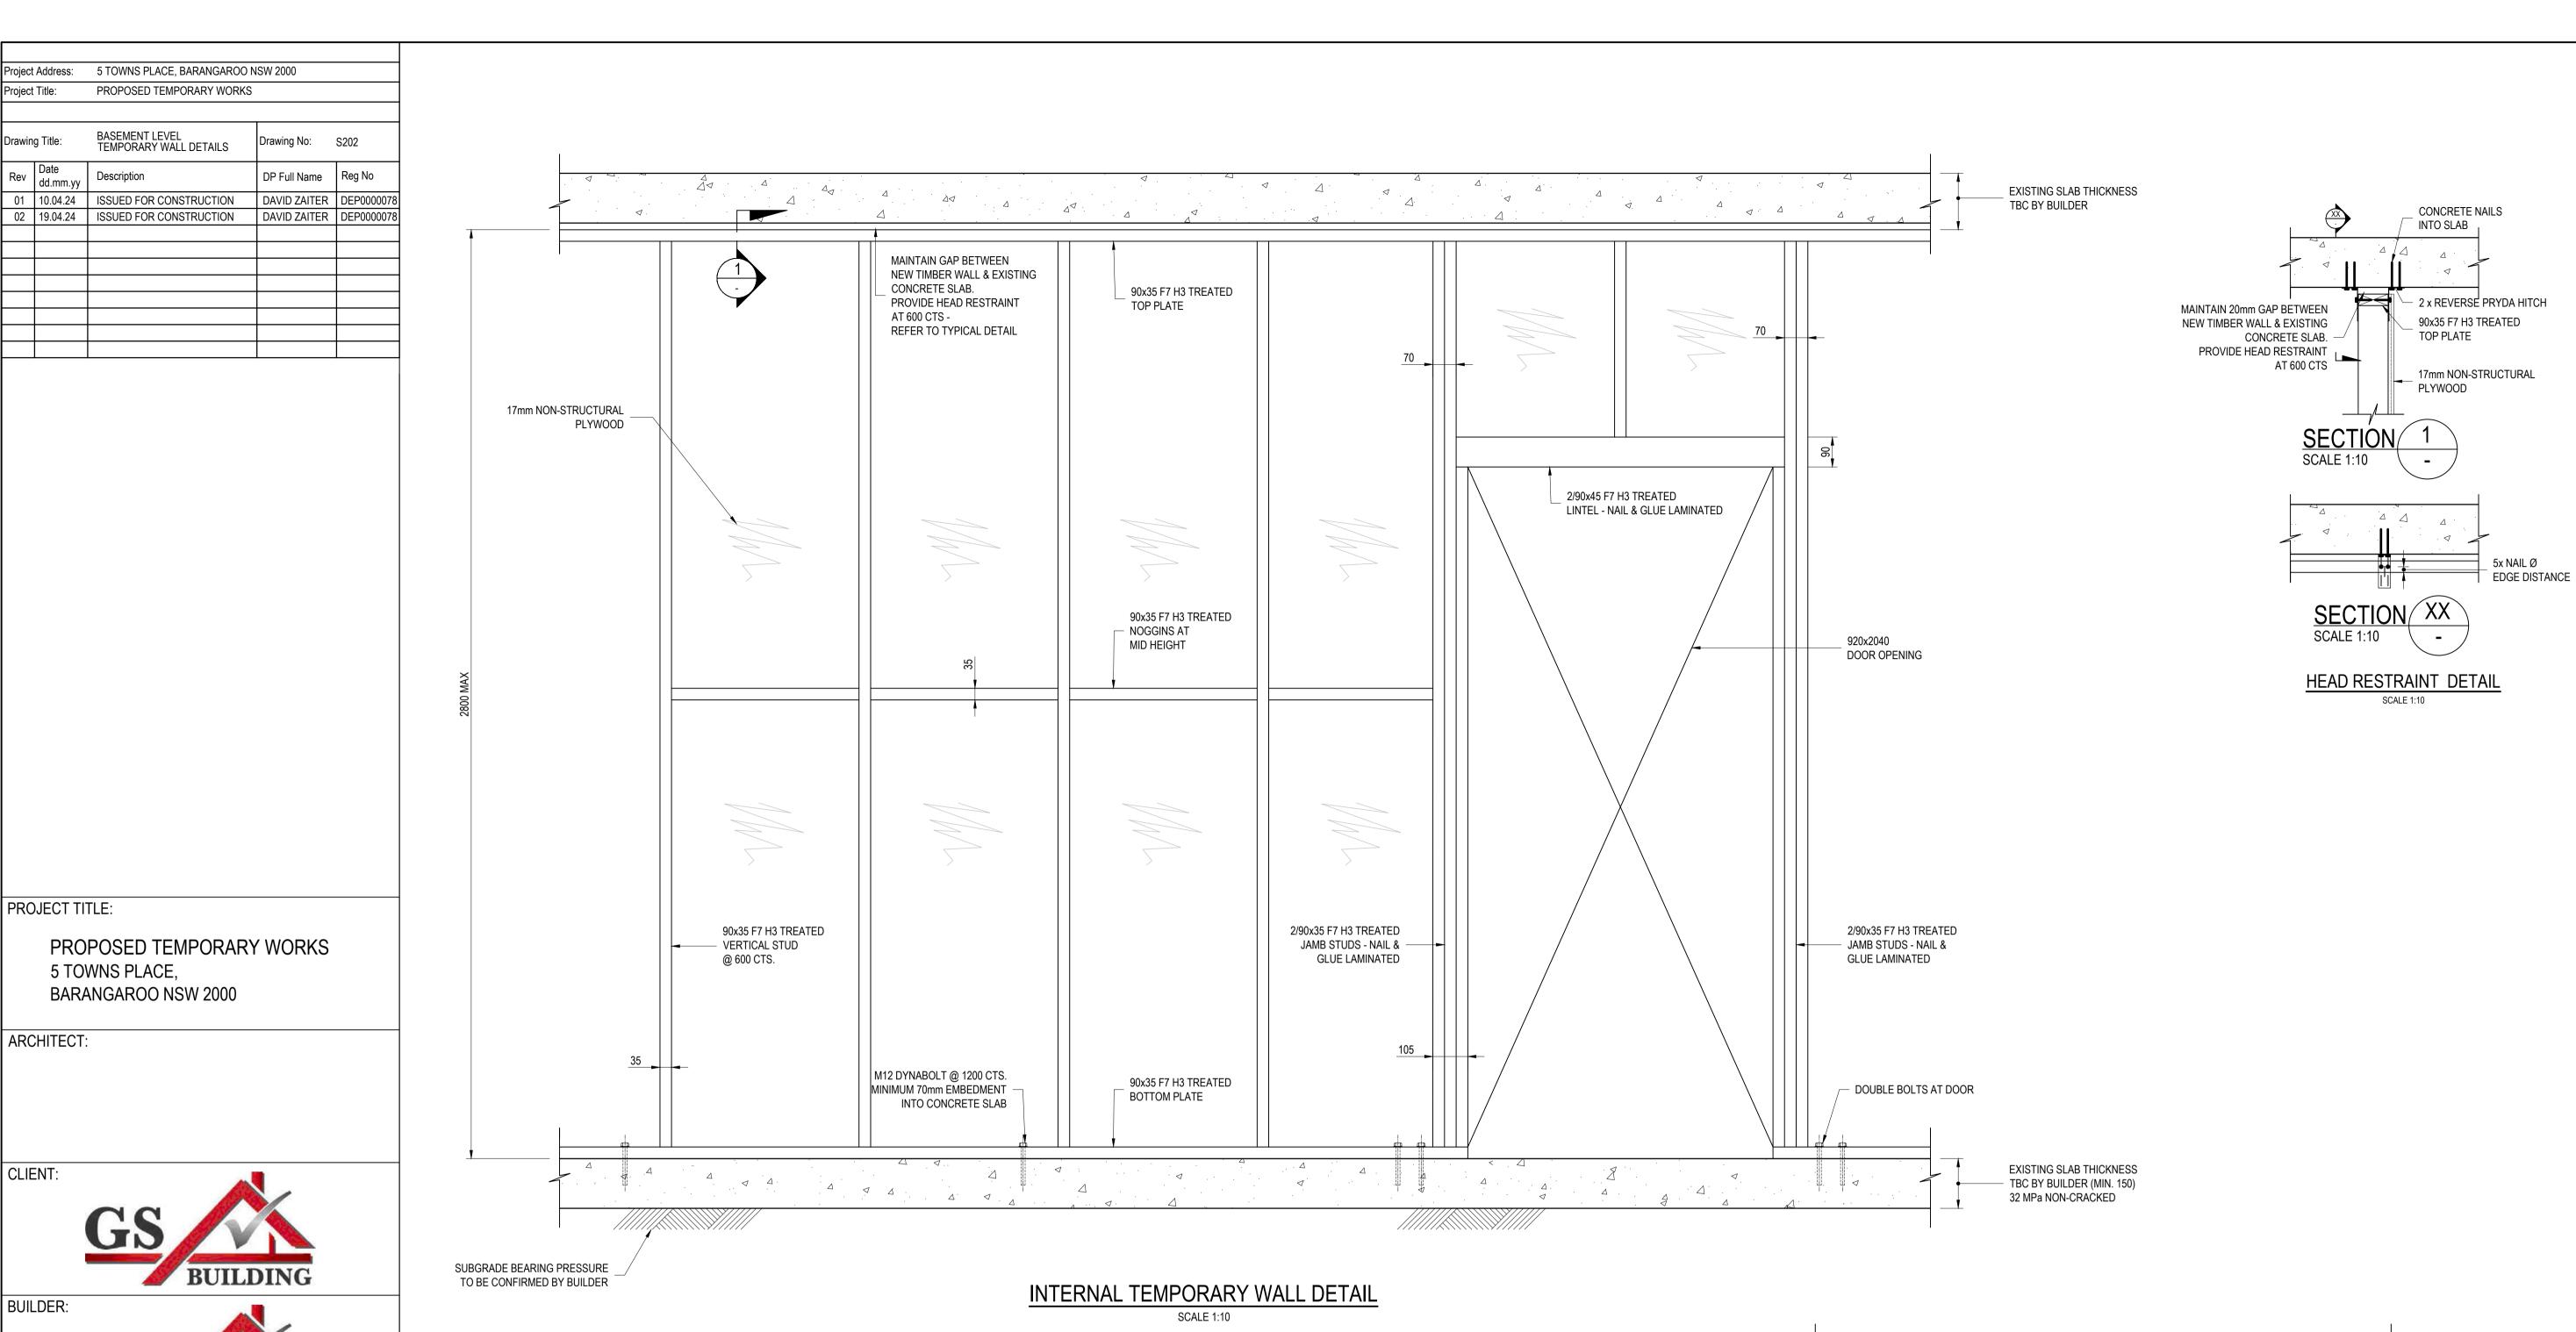





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DRAWING TITLE:

JOB No.


BASEMENT LEVEL TEMPORARY WALL DETAILS

DRAWING STATUS:		ISSUED FOR CONSTRUCT
DESIGNED:	YM	DAVID ZAITER BEng(Hons). MIEAust. CPEng NER RPEQ
DRAWN:	EE	SCALE SIZE
CHECKED:	DΖ	As indicated A1

As indicated REV. DRAWING No. 24-3924 S202 02

### NOTE: LAMINATING BEAMS TOGETHER BEAM TO BEAM:


- OPTION 1. NAIL LAMINATION 3 ROWS AT 300 CTS (USE 3.75 DIAM x 90mm NAIL)
- OPTION 2. BOLTING 2x 12mm MS BOLTS WITH Ø55mm WASHER AT 600 CTS (AS PER AS1720.1 TABLE 4.12)
- PROVIDE BEAD OF ELASTOMERIC ADHESIVE TOP & BTM

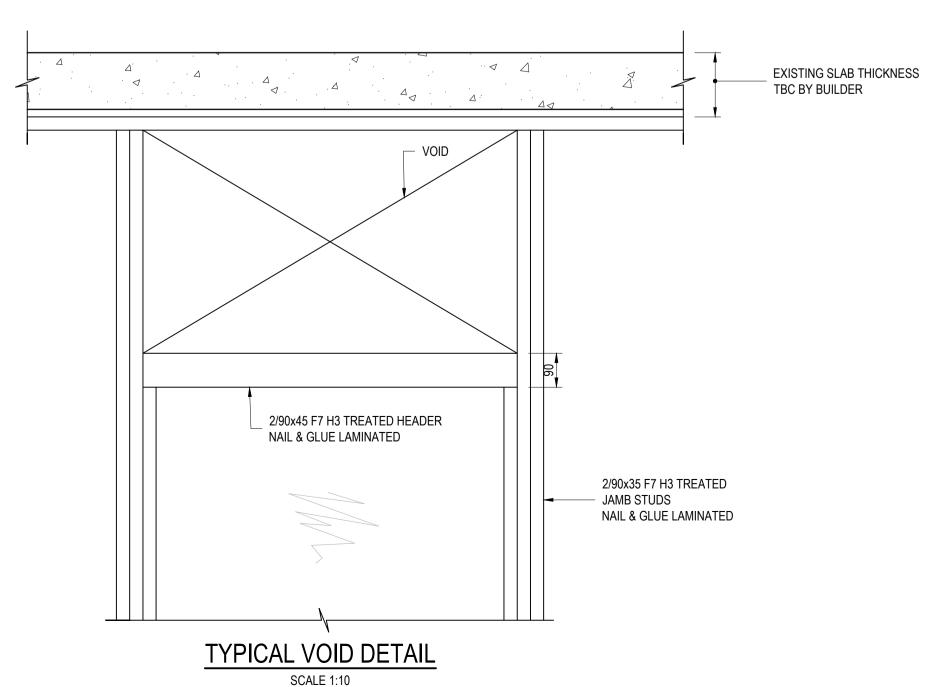



### 4.0 Appendix D – Emergency Egress Plans

Dial 000 for emergency services

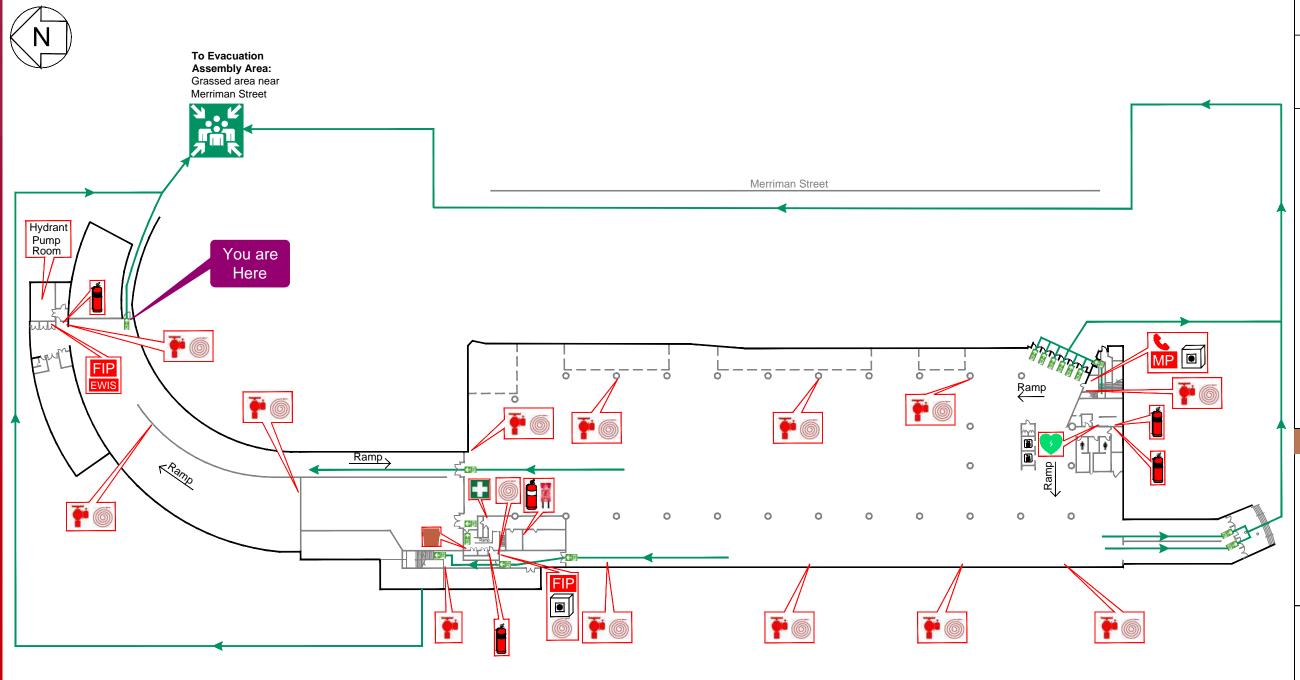


#### **Barangaroo Cutaway**

GROUND FLOOR Town Place, Millers Point NSW 2000

- Remove people from danger:
- Yourself, staff and visitors
- A Raise the *Alarm*:
- Call Security on 02 9247 7231
- Call 000
- C Contain the fire:
- Close doors behind you
- **E** Evacuate:
- Go to the Assembly Area
- Only attempt to extinguish fire if it's safe to do so

#### LOCKDOWN:

- Gather people together out of sight
- Close and lock doors & windows
- Close blinds & turn off lights
- Switch mobile phones to silent
- KEEP QUIET & REMAIN CALM
- Barricade door with furniture if necessary
- Await instructions of lockdown completion
- In a life threatening emergency call 000 for emergency assistance

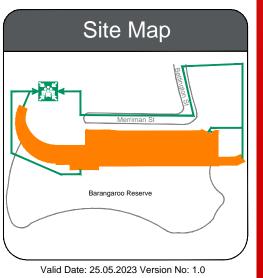

Legend







Evacuation Route





**EWIS** Emergency Warden

Intercomm. System

Defibrillator











MP Mimic Panel



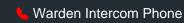



Dial 000 for emergency services

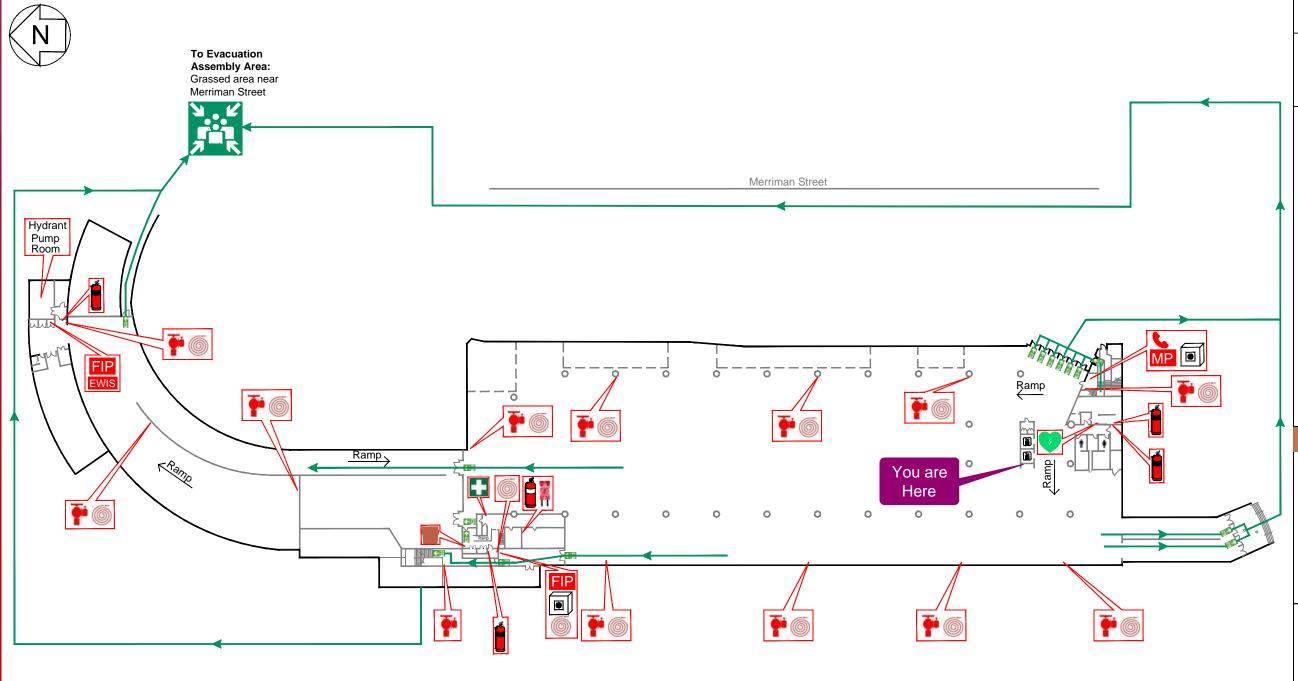


#### **Barangaroo Cutaway**

**GROUND FLOOR** Town Place, Millers Point NSW 2000


- Remove people from danger:
- Yourself, staff and visitors
- Raise the *Alarm*:
- Call Security on 02 9247 7231
- Call 000
- Contain the fire:
- Close doors behind you
- Evacuate:
- Go to the Assembly Area
- Only attempt to extinguish fire if it's safe to do so

#### LOCKDOWN:

- Gather people together out of sight
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- for emergency assistance

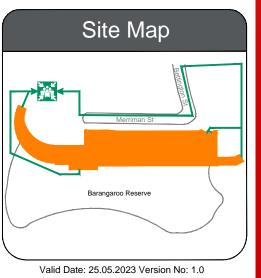



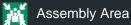






White Break Glass Alarm

-> Evacuation Route




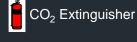

**EWIS** Emergency Warden

Intercomm. System



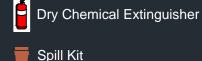




MP Mimic Panel







Dial 000 for emergency services

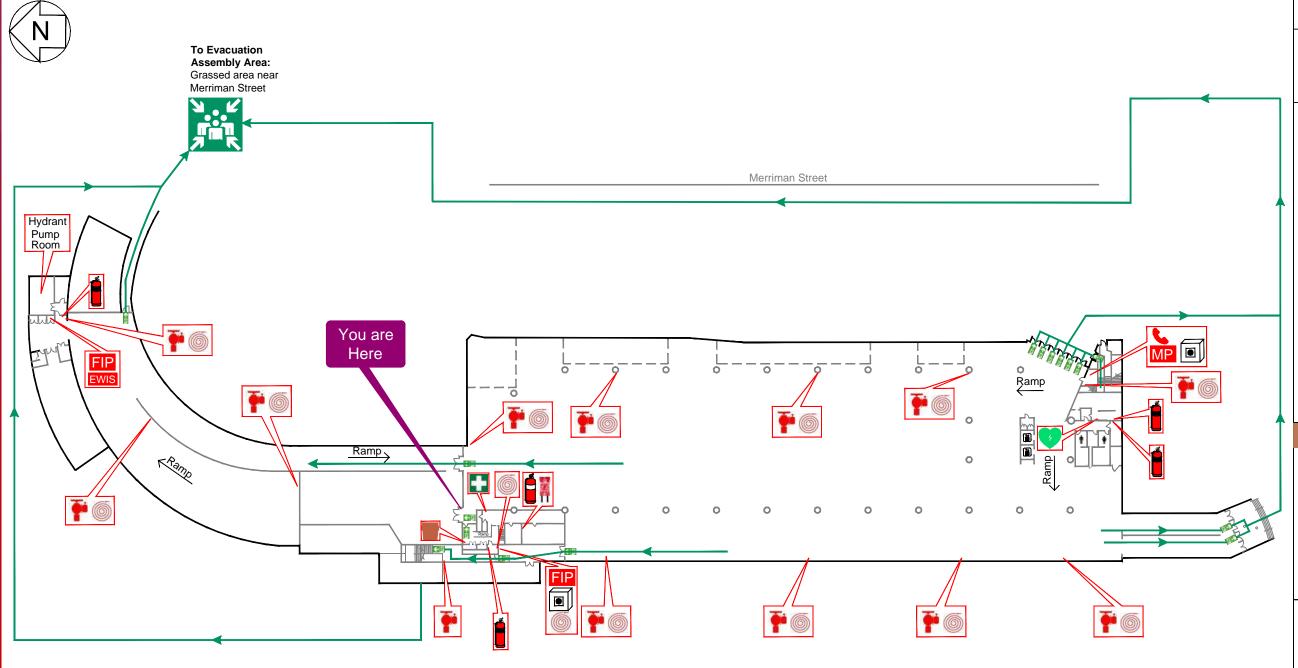


#### **Barangaroo Cutaway**


**GROUND FLOOR** Town Place, Millers Point NSW 2000

- Remove people from danger:
- Yourself, staff and visitors
- Raise the *Alarm*:
- Call Security on 02 9247 7231
- Call 000
- Contain the fire:
- Close doors behind you
- Evacuate:
- Go to the Assembly Area
- Only attempt to extinguish fire if it's safe to do so


#### LOCKDOWN:

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- In a life threatening emergency call 000

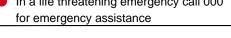

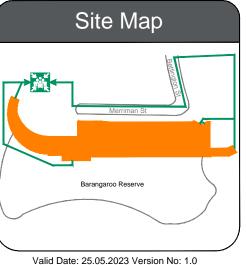



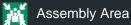

Alarm





-> Evacuation Route







**EWIS** Emergency Warden

Intercomm. System



Dry Chemical Extinguisher








MP Mimic Panel





Dial 000 for emergency services

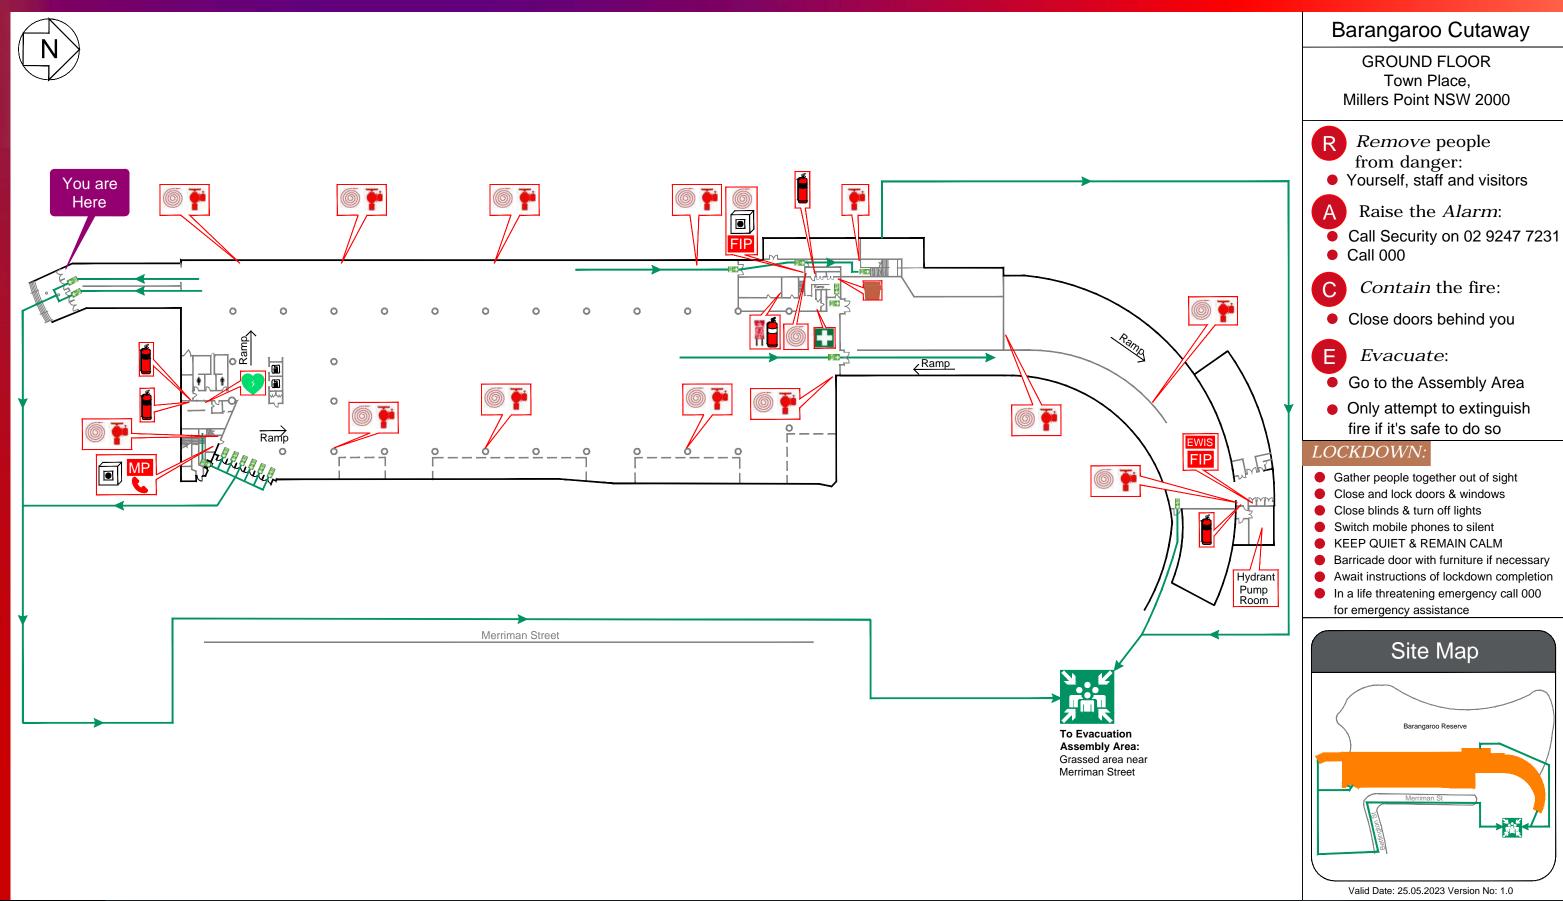

Legend

Fire Blanket

Assembly Area

Alarm

First Aid Kit White Break Glass

FIP Fire Indicator Panel

-> Evacuation Route

CO<sub>2</sub> Extinguisher Defibrillator

**EWIS** Emergency Warden

Intercomm. System

Dry Chemical Extinguisher

Spill Kit


Fire Hydrant

MP Mimic Panel

Fire Hose Reel

Warden Intercom Phone


Dial 000 for emergency services

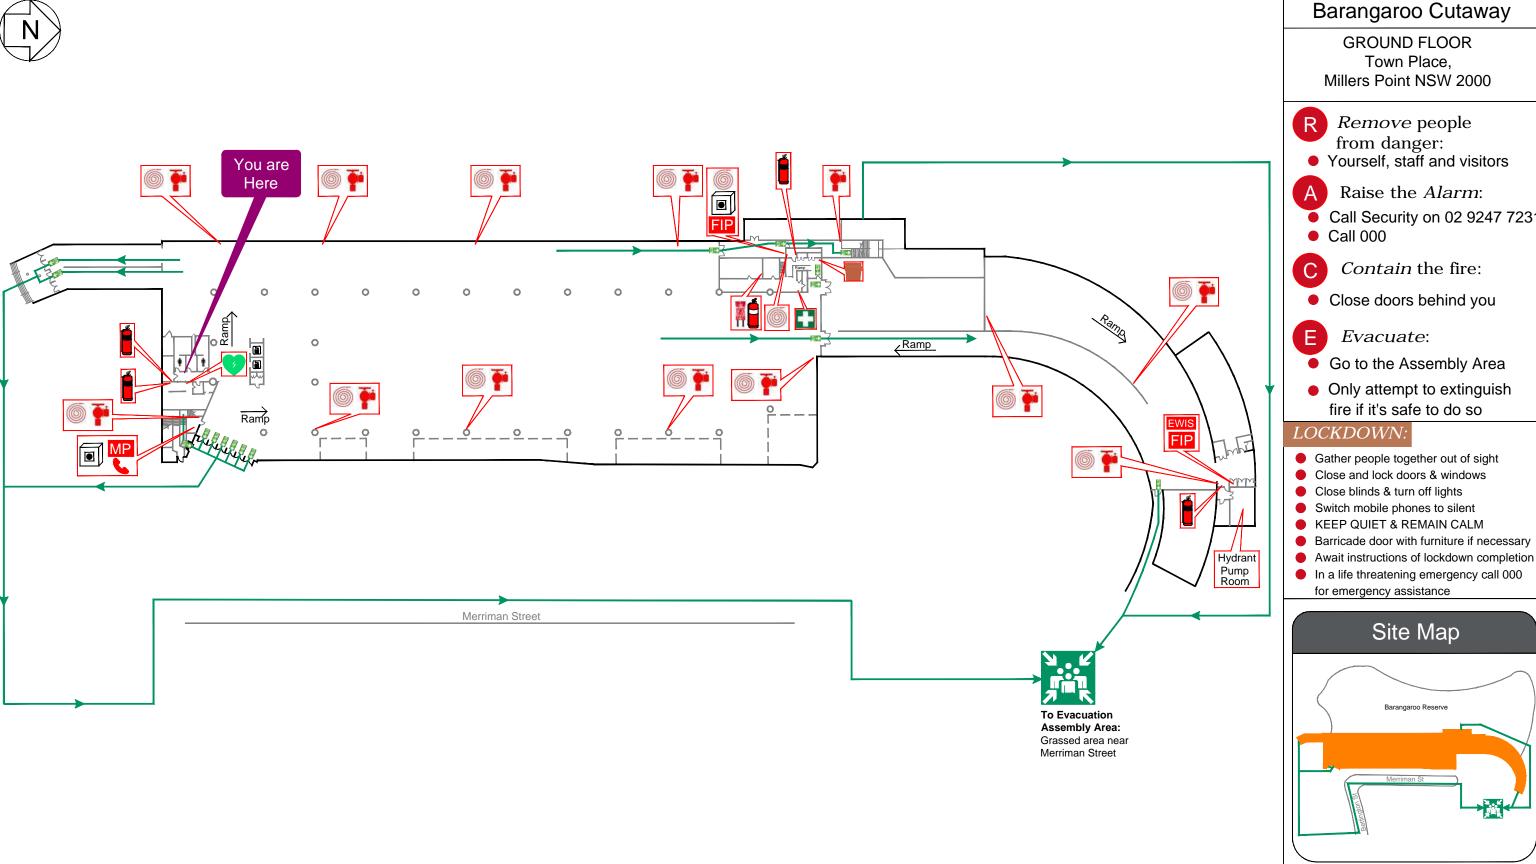

**Barangaroo Cutaway** 

**GROUND FLOOR** Town Place, Millers Point NSW 2000

- Remove people from danger:
- Yourself, staff and visitors
- Raise the *Alarm*:
- Call Security on 02 9247 7231
- Contain the fire:
- Close doors behind you
- Go to the Assembly Area
- Only attempt to extinguish fire if it's safe to do so
- Close and lock doors & windows
- Close blinds & turn off lights
- Switch mobile phones to silent
- KEEP QUIET & REMAIN CALM
- In a life threatening emergency call 000 for emergency assistance

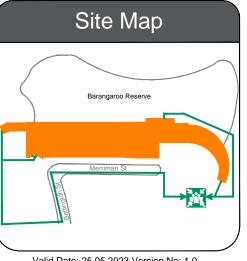

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Legend








Alarm



-> Evacuation Route




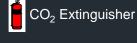

**EWIS** Emergency Warden

Intercomm. System



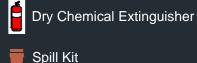






Warden Intercom Phone



Dial 000 for emergency services

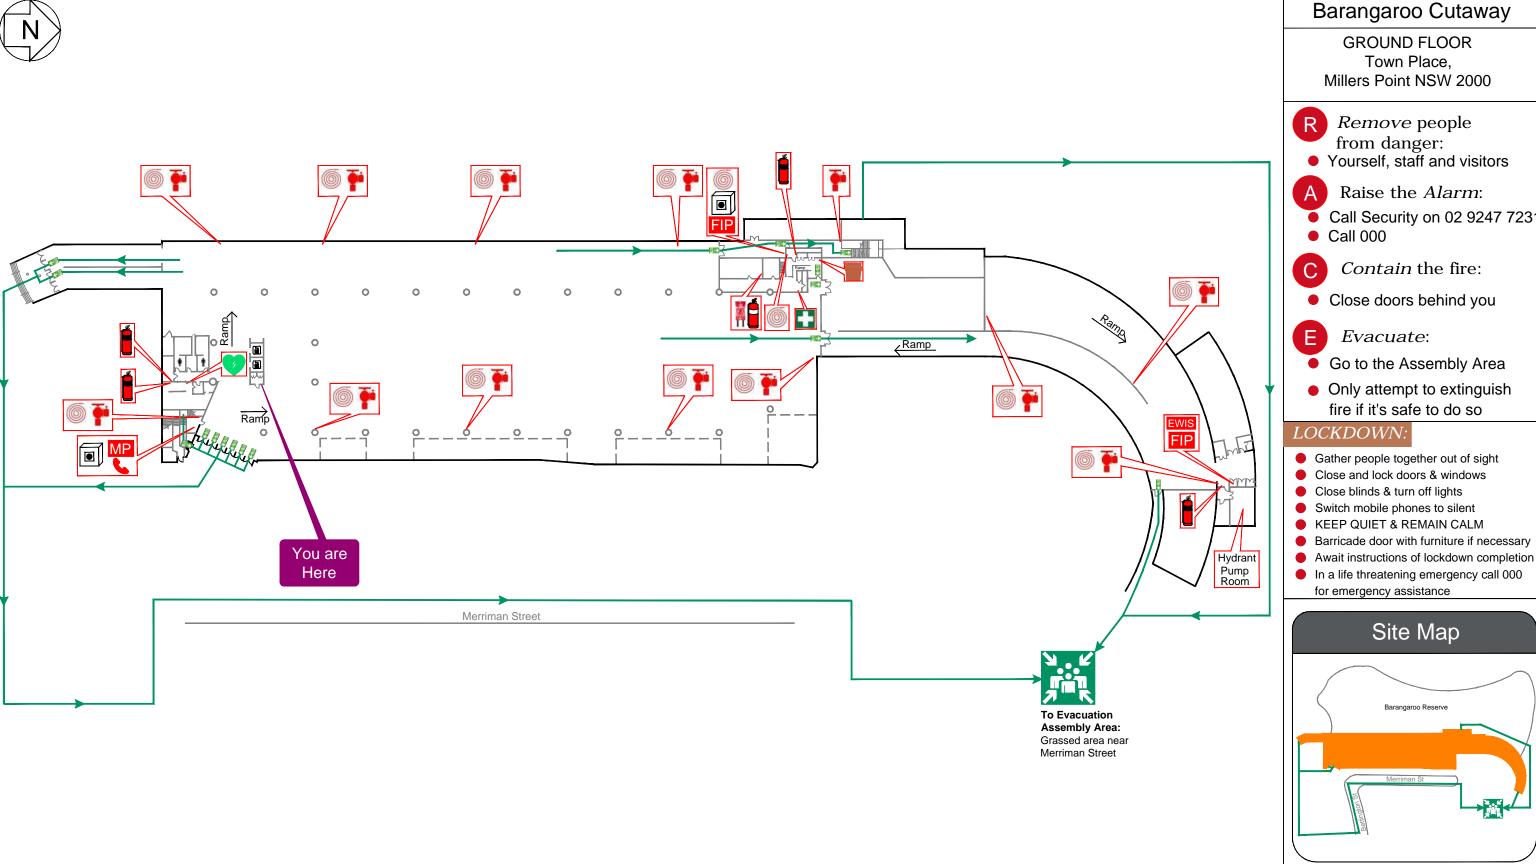

**Barangaroo Cutaway** 

**GROUND FLOOR** Town Place, Millers Point NSW 2000

- Remove people from danger:
- Yourself, staff and visitors
- Raise the *Alarm*:
- Call Security on 02 9247 7231
- Contain the fire:
- Close doors behind you
- Go to the Assembly Area
- Only attempt to extinguish fire if it's safe to do so
- Close and lock doors & windows
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- In a life threatening emergency call 000 for emergency assistance



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Legend



Assembly Area



Alarm

White Break Glass

First Aid Kit

FIP Fire Indicator Panel

-> Evacuation Route

CO<sub>2</sub> Extinguisher

Defibrillator **EWIS** Emergency Warden

Intercomm. System

Spill Kit

Dry Chemical Extinguisher

Fire Hydrant


MP Mimic Panel

Fire Hose Reel

Warden Intercom Phone



Dial 000 for emergency services

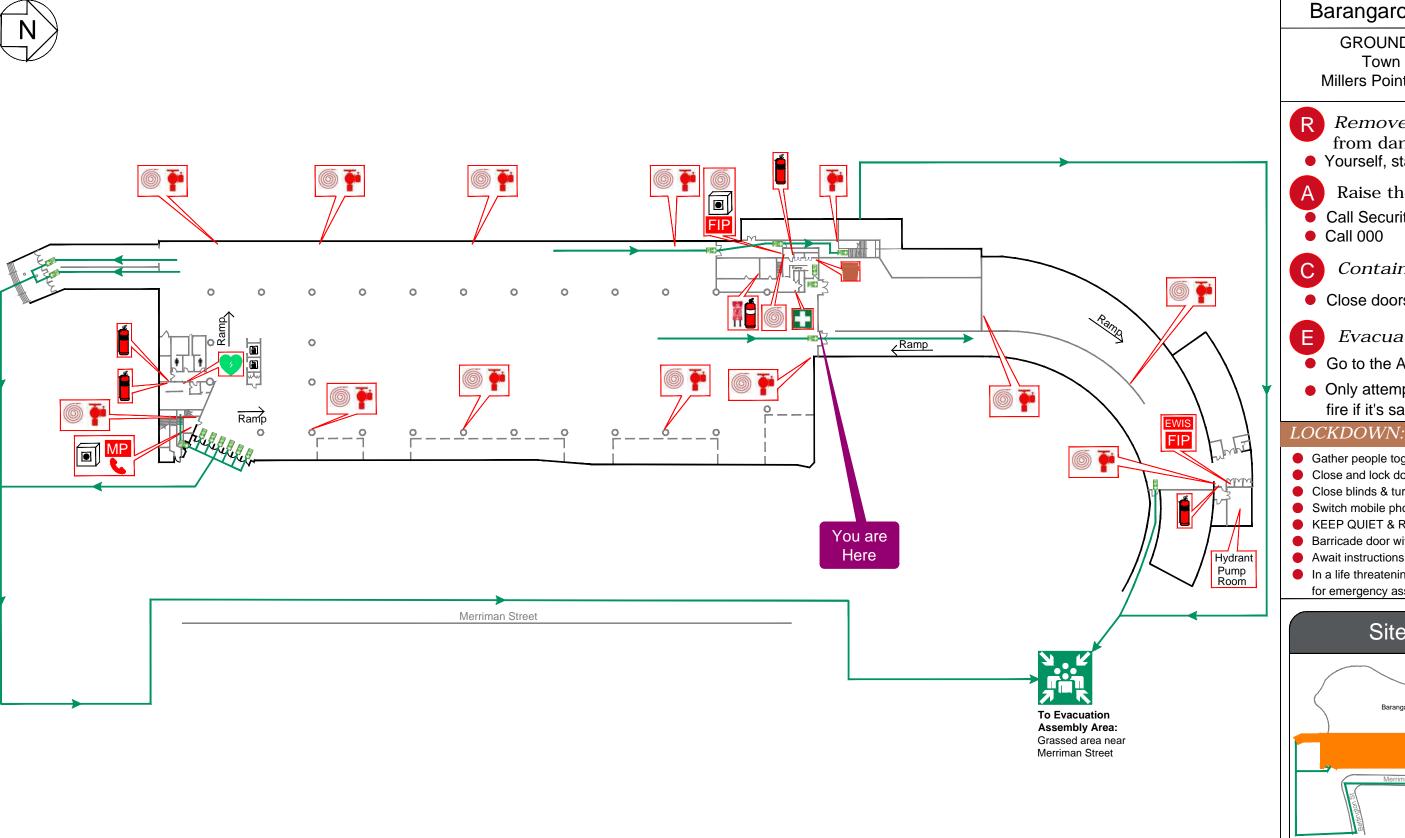


#### **Barangaroo Cutaway**

**GROUND FLOOR** Town Place, Millers Point NSW 2000


- Remove people from danger:
- Yourself, staff and visitors
- Raise the *Alarm*:
- Call Security on 02 9247 7231
- Contain the fire:
- Close doors behind you
- Evacuate:
- Go to the Assembly Area
- Only attempt to extinguish fire if it's safe to do so

- Gather people together out of sight
- Close and lock doors & windows
- Close blinds & turn off lights
- Switch mobile phones to silent
- KEEP QUIET & REMAIN CALM
- Barricade door with furniture if necessary
- Await instructions of lockdown completion
- In a life threatening emergency call 000 for emergency assistance

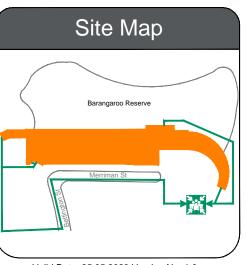

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Legend



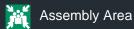

Alarm

White Break Glass

First Aid Kit FIP Fire Indicator Panel

-> Evacuation Route



Defibrillator

**EWIS** Emergency Warden

Intercomm. System



Dry Chemical Extinguisher








MP Mimic Panel





Dial 000 for emergency services



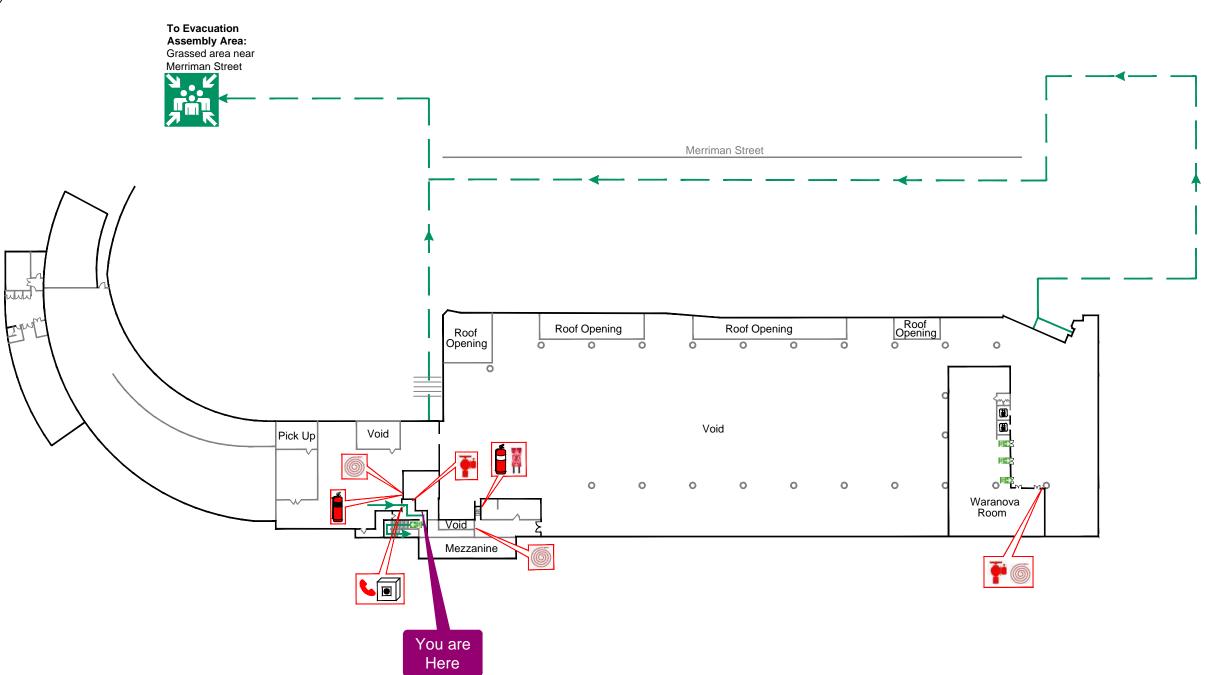


#### **Barangaroo Cutaway**

LEVEL 1 Town Place, Millers Point NSW 2000

- Remove people from danger:
- Yourself, staff and visitors
- Raise the *Alarm*:
- Call Security on 02 9247 7231
- Call 000
- *Contain* the fire:
- Close doors behind you
- Evacuate:
- Go to the Assembly Area
- Only attempt to extinguish fire if it's safe to do so

#### LOCKDOWN:

- Gather people together out of sight
- Close and lock doors & windows
- Close blinds & turn off lights
- Switch mobile phones to silent
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- Barricade door with furniture if necessary Await instructions of lockdown completion
- In a life threatening emergency call 000
- for emergency assistance

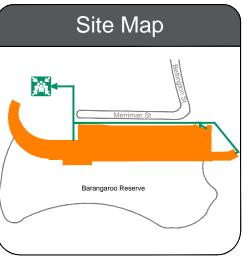

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Legend



Assembly Area










Dry Chemical Extinguisher





Dial 000 for emergency services



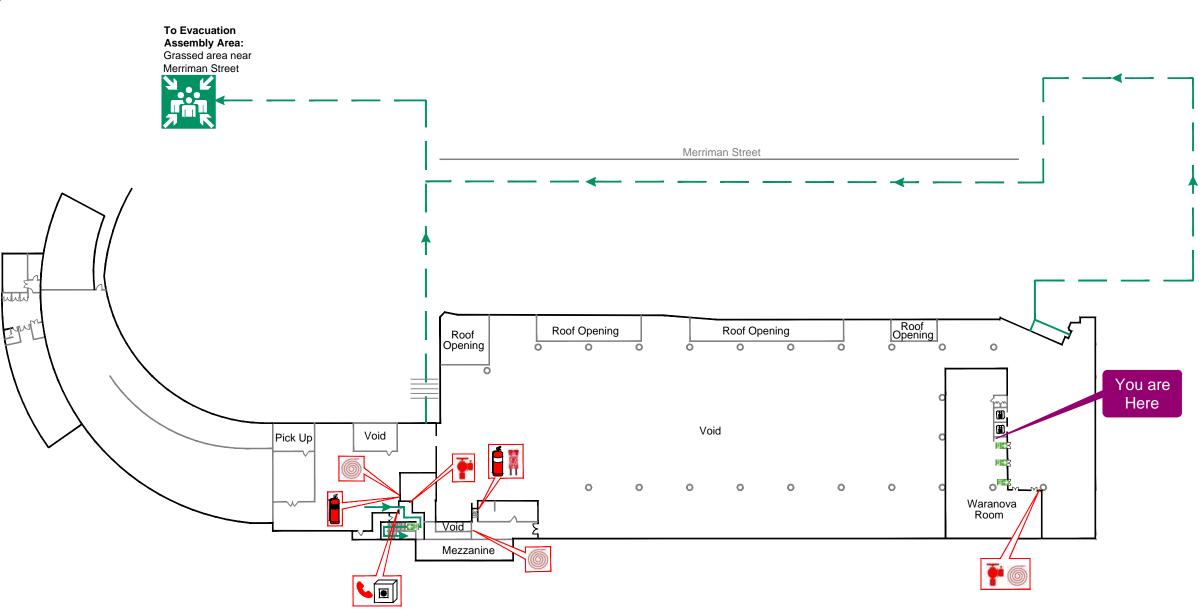


#### **Barangaroo Cutaway**

LEVEL 1 Town Place, Millers Point NSW 2000

- Remove people from danger:
- Yourself, staff and visitors
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- Call Security on 02 9247 7231
- Call 000
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Legend





Assembly Area

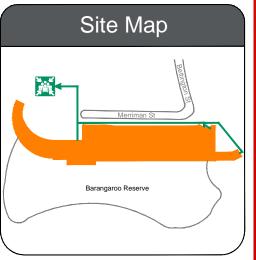
Fire Blanket





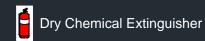

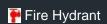


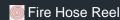



### Dial 000 for emergency services



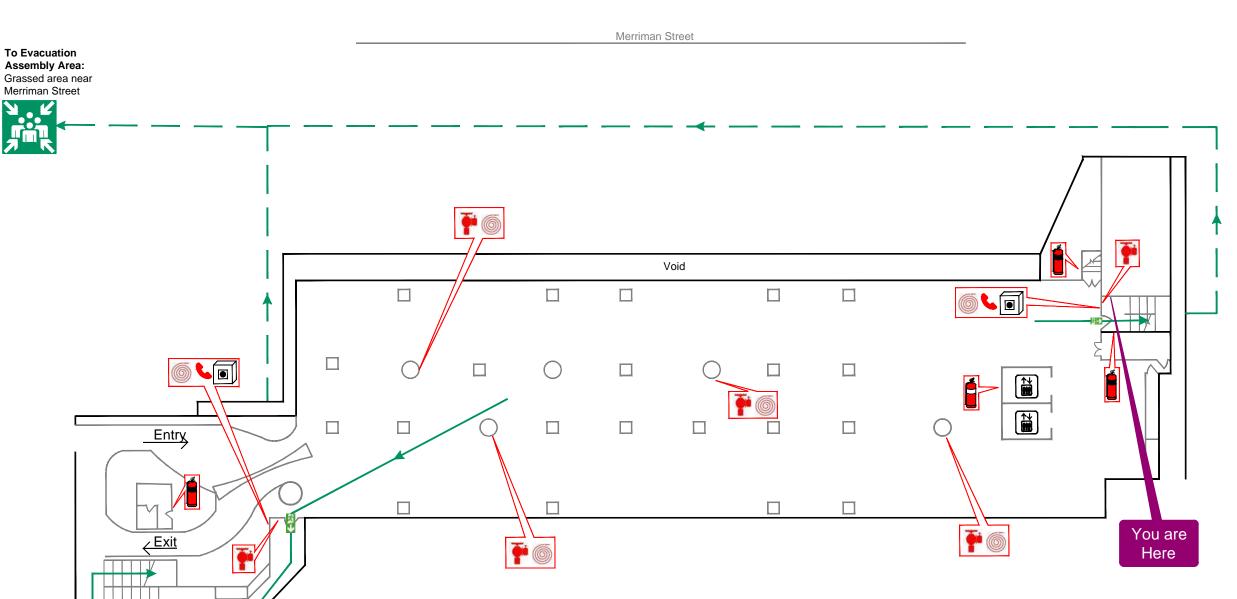


#### **Barangaroo Cutaway**

**BASEMENT 1** Town Place, Millers Point NSW 2000

- Remove people from danger:
- Yourself, staff and visitors
- Raise the *Alarm*:
- Call Security on 02 9247 7231
- Call 000
- Contain the fire:
- Close doors behind you
- Evacuate:
- Go to the Assembly Area
- Only attempt to extinguish fire if it's safe to do so

#### LOCKDOWN:

- Gather people together out of sight
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Legend

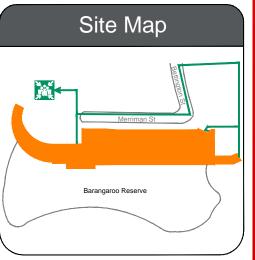













Dry Chemical Extinguisher

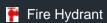



Dial 000 for emergency services



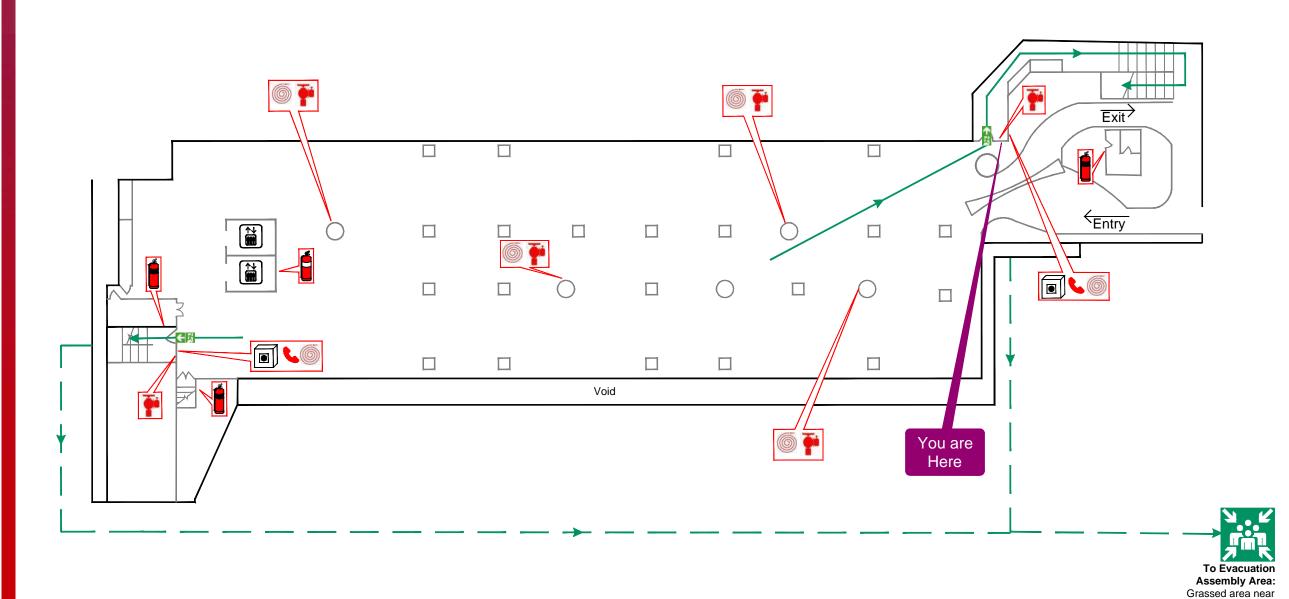


#### Barangaroo Cutaway

BASEMENT 1 Town Place, Millers Point NSW 2000

- Remove people from danger:
- Yourself, staff and visitors
- A Raise the *Alarm*:
- Call Security on 02 9247 7231
- Call 000
- *Contain* the fire:
- Close doors behind you
- **E** Evacuate:
- Go to the Assembly Area
- Only attempt to extinguish fire if it's safe to do so

#### LOCKDOWN:

- Gather people together out of sight
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- KEEP QUIET & REMAIN CALM
- Barricade door with furniture if necessaryAwait instructions of lockdown completion
- In a life threatening emergency call 000
  - for emergency assistance

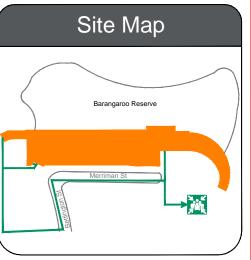

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Legend





Evacuation Route



Merriman Street



Dry Chemical Extinguisher






Merriman Street



Dial 000 for emergency services



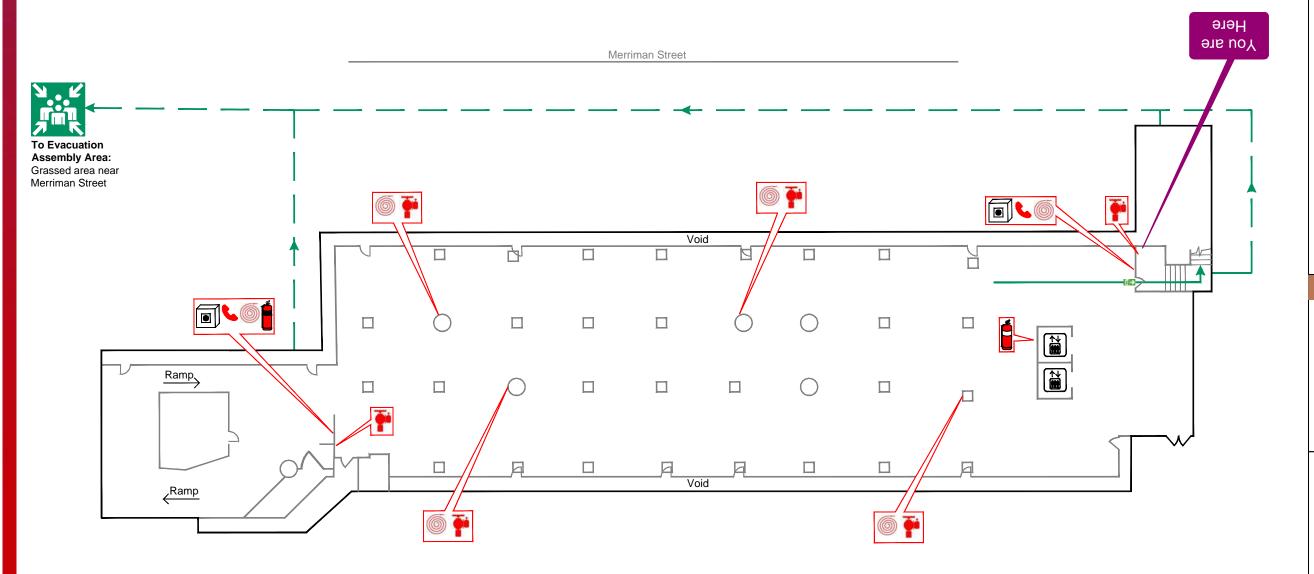

#### **Barangaroo Cutaway**


BASEMENT 2 Town Place, Millers Point NSW 2000

- Remove people from danger:
- Yourself, staff and visitors
- Raise the *Alarm*:
- Call Security on 02 9247 7231
- Call 000
- Contain the fire:
- Close doors behind you
- Evacuate:
- Go to the Assembly Area
- Only attempt to extinguish fire if it's safe to do so

#### LOCKDOWN:

- Gather people together out of sight
- Close and lock doors & windows
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- Switch mobile phones to silent
- KEEP QUIET & REMAIN CALM
- Barricade door with furniture if necessary Await instructions of lockdown completion
- In a life threatening emergency call 000

### for emergency assistance

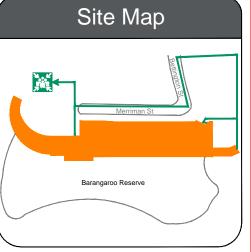

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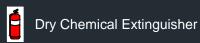
Legend













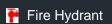



Dial 000 for emergency services



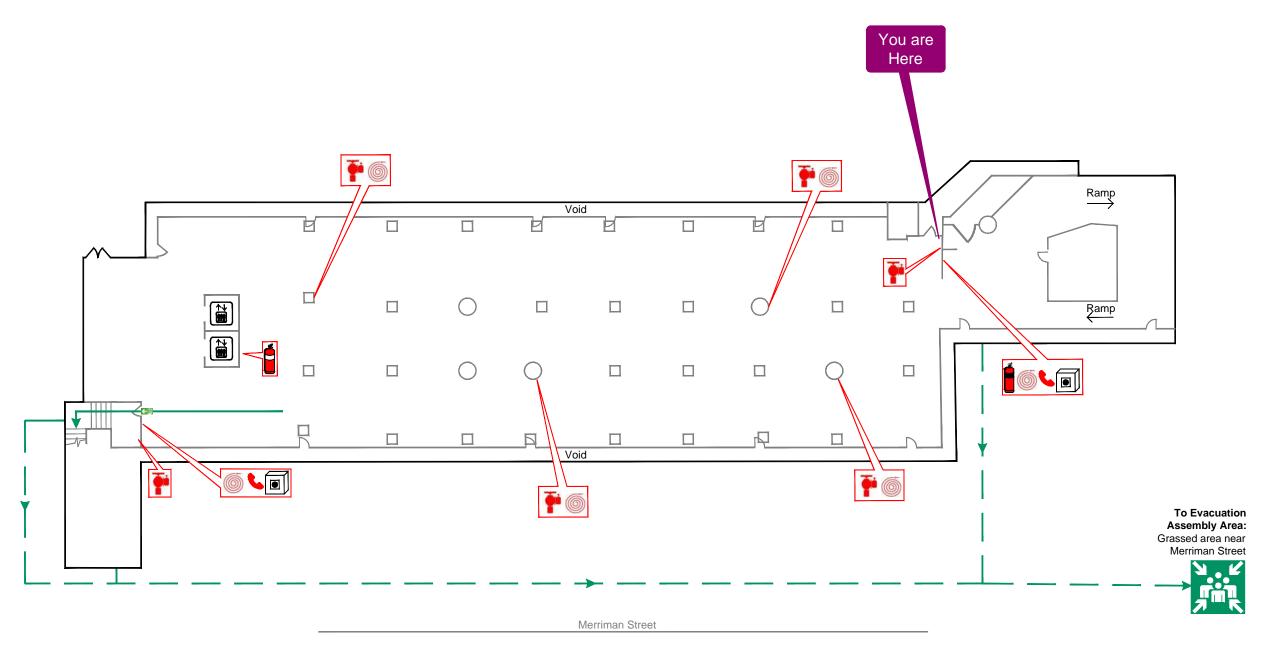


#### **Barangaroo Cutaway**

BASEMENT 2 Town Place, Millers Point NSW 2000

- Remove people from danger:
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- Raise the *Alarm*:
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- Contain the fire:
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- Only attempt to extinguish fire if it's safe to do so


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Legend



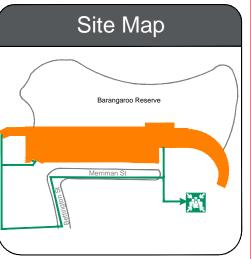



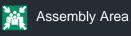

CO<sub>2</sub> Extinguisher



Dry Chemical Extinguisher



